## **ELECTRICAL NOTES:**

- 1. BREAKERS SHALL HAVE "AIC" RATING GREATER THAN THE FAULT CURRENT. ELECTRICAL CONTRACTOR IS TO CONTACT POWER COMPANY FOR AVAILABLE FAULT CURRENT. SERIES RATING IS PERMISSIBLE. ALL PANELS ARE TO BE MARKED WITH AVAILABLE FAULT CURRENT VALUES IN ACCORDANCE WITH NEC ARTICLE 110.24.
- 2. FUSES IN SERVICE DISCONNECTS SHALL BE CURRENT LIMITING TYPE.
- 3. COORDINATE ALL HVAC WIRING WITH MECHANICAL CONTRACTOR.
- 4. EMERGENCY LIGHTING AND EXIT SIGNS TO BE CONNECTED AHEAD OF ANY SWITCHING.
- 5. WIRE TO BE COPPER TYPE THWN (EXTERIOR) AND COPPER TYPE THHN (INTERIOR) OR APPROVED EQUAL UNLESS
- COORDINATE LOCATION OF ALL DEVICES AND MOUNTING HEIGHTS OF RECEPTACLES WITH OWNER.
- 7. ALL ELECTRICAL COMPONENTS ARE TO BE UL LISTED.
- 8. EQUIPMENT GROUND CONDUCTOR TO BE PROVIDED IN ACCORDANCE WITH NEC SECTION 250.
- 9. ALL INTERIOR WIRING TO BE RUN IN EMT OR MC CABLE EXCEPT WHERE PROHIBITED BY THE NATIONAL ELECTRIC
- 10. EXHAUST FANS ARE TO BE FURNISHED AND INSTALLED BY MECHANICAL CONTRACTOR. FANS TO BE WIRED BY ELECTRICAL CONTRACTOR.
- 11. ALL EXTERIOR LIGHTING TO BE WIRED THROUGH A LIGHTING CONTACTOR AND CONTROLLED BY A PHOTOCELL AND TIMECLOCK.
- 12. THE CONTRACTOR SHALL COORDINATE THE LOCATION OF ALL CONDUIT AND EQUIPMENT WITH ALL OTHER TRADES PRIOR TO BEGINNING INSTALLATION TO AVOID CONFLICTS AND INTERFERENCE WITH OTHER TRADES.
- 13. FINAL UTILITY CONNECTIONS (GAS, ELECTRIC, WATER, ETC.) TO EQUIPMENT SHALL BE MADE BY THE CONTRACTOR INSTALLING THE EQUIPMENT REQUIRING THE UTILITIES.
- 14. ELECTRICAL DRAWINGS ARE DIAGRAMMATIC. THERE IS NO INTENT TO INDICATE ALL FITTINGS REQUIRED. GENERALLY, CONDUIT SHALL BE INSTALLED PARALLEL OR PERPENDICULAR TO AND PLUMB WITH WALL CONSTRUCTION.
- 15. REFER TO ARCHITECTURAL DRAWINGS FOR DIMENSIONED LOCATIONS OF WALL AND PARTITIONS AND FOR PARTITION THICKNESS AND CONSTRUCTION MATERIALS.
- 16. ELECTRICAL POWER REQUIREMENTS FOR HVAC EQUIPMENT ARE BASED ON MANUFACTURER'S PUBLISHED DATA.
  ELECTRICAL CONTRACTOR SHALL COORDINATE WITH GENERAL CONTRACTOR AND/OR MECHANICAL CONTRACTOR TO
  CONFIRM ELECTRICAL REQUIREMENTS HAVE NOT CHANGED DUE TO EQUIPMENT SUBSTITUTIONS OR OTHER CHANGES
  PRIOR TO PROVIDING FINAL BID AND PRIOR TO PURCHASING PANELS, CIRCUIT WIRING AND CIRCUIT BREAKERS
  SERVING HVAC EQUIPMENT.
- 17. ALL RECEPTACLES 18" A.F.F. TO BOTTOM OF BOX UNLESS OTHERWISE NOTED.
- 18. ALL NEW AND/OR ALTERED WIRING IS REQUIRED TO BE PERMITTED AND INSPECTED FOR COMPLIANCE WITH CURRENT NEC.
- 19. ALL PRE-WIRED EQUIPMENT SHALL BE LISTED BY STATE OF NC APPROVED 3RD PARTY AGENCY, [NEC 90.7; 110.3(B)].
- 20. ALL WIRING, INCLUDING LOW VOLTAGE, DATA, PHONE, FIRE ALARM, SECURITY, HVAC CONTROLS, AND POWER SHALL BE PERMITTED AND INSPECTED PER NC GENERAL STATUES.
- 21. CLEARANCE REQUIRED AT ELECTRICAL EQUIPMENT, (NEC 110.26).
- 22. SERVICE EQUIPMENT SHALL BE LEGIBLY MARKED IN THE FIELD WITH THE MAXIMUM AVAILABLE FAULT CURRENT. THE FIELD MARKING(S) SHALL INCLUDE THE DATE THE FAULT CURRENT CALCULATION WAS PERFORMED AND BE OF SUFFICIENT DURABILITY TO WITHSTAND THE ENVIRONMENT INVOLVED. NEC 110.24(A)
- 23. ALL ELECTRICAL TO BE INSTALLED IN ACCORDANCE WITH LATEST ADOPTED NEC.

FEEDER TABLE					
	TYPE				
OVERCURRENT PROTECTION	С	COPPER		UMINUM	
, , , , , , , , , , , , , , , , , , ,	WIRE* CONDUIT*		WIRE*	CONDUIT*	
15	#14	1/2"	<b>#</b> 12	1/2"	
20	<b>#</b> 12	1/2"	<b>#</b> 10	1/2"	
25	#10	1/2"	<b>#</b> 10	1/2"	
30	<b>#</b> 10	1/2"	#8	3/4"	
35	#8	1/2"	#8	3/4"	
40	#8	3/4"	#8	3/4"	
45	#8	3/4"	#6	1"	
50	#8	3/4"	#6	1"	
55	#6	1"	#4	1-1/4"	
60	#6	1"	#4	1-1/4"	
70	#4	1-1/4"	#3	1-1/4"	
80	#4	1-1/4"	#2	1-1/4"	
90	#3	1-1/4"	#2	1-1/4"	
100	#3	1-1/4"	#1	1-1/2"	
110	#2	1-1/4"	#1/0	2"	
125	#1	1-1/2"	#2/0	2"	
150	#1/0	2"	#3/0	2"	
175	#2/0	2"	#4/0	2-1/2"	
200	#3/0	2"	#250	2-1/2"	
225	#4/0	2"-1/2"	#300	2"-1/2"	


\*UNLESS OTHERWISE NOTED

ELECTRICAL LEGEND					
SYMBOL	DESCRIPTION				
<b>=</b>	120V DUPLEX RECEPTACLE				
€=	120V DUPLEX RECEPTACLE, GROUND FAULT INTERRUPTER				
<b>⊕</b> WP	120V DUPLEX RECEPTACLE, GROUND FAULT INTERRUPTER, WEATHER PROOF				
	240V RECEPTACLE				
<b>*</b>	FLOOR MOUNTED 120V QUAD RECEPTACLE				
급	UNFUSED DISCONNECT				
<b>•</b>	TELE/DATA OUTLET				
<b>▷</b> ™	TV CABLE OUTLET				
<b>(</b> )	JUNCTION BOX				
	ELECTRICAL PANEL				
AC	DENOTES RECEPTACLES TO BE MOUNTED ABOVE COUNTER AT 42" AFF				

PANEL A - LOAD CALCULATION SUMMARY						
ITEM	TOTAL VA	(X) D.F.	VA			
LIGHTING	1,583	125 (%)	1,979			
EXTERIOR LIGHTING	0	125 (%)	0			
RECEPTS. (FIRST 10 KVA)	9,330	100 (%)	9,330			
RECEPTS. (REMAINING KVA @50%)	0	50 (%)	0			
HVAC	14,700	100 (%)	14,700			
SHOW WINDOWS	0	125 (%)	0			
WATER HEATER	4,500	125 (%)	5,625			
SIGN	0	125 (%)	0			
MOTORS	0	125 (%)	0			
EQUIPMENT	8,000	100 (%)	8,000			
KITCHEN EQUIPMENT	0	70 (%)	0			
TOTAL	38,113		39,634			
٦	OTAL AMPS	= VA/240 =	165			


\* RECEPTACLES ARE CALCULATED PER NEC TABLE 220.44

* HVAC NAME PLATE RATING INCLUDES 125% DIVERSITY FACTOR	

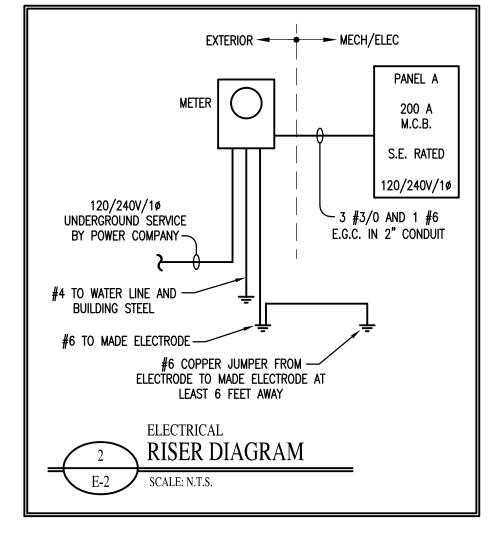

PANELBOARD SCHEDULE									
	PANEL	: A	VOLTS:	240V/120		MOUNT	: SURFACE		
MAIN: MCB		MCB	AMPS: 200		•	AIC	(SEE NOTE 1)	<del></del>	
		S.E. RATED	PH/MRE:	1/3		LOC	.: MECH/ELECT		
	AMPS/		LOAD	LOAD BY F	PHASE, VA	LOAD		AMPS/	
CIR.	POLES	DESCRIPTION OF LOAD	VA	Α	В	VA	DESCRIPTION OF LOAD	POLES	CIR.
1	20/1	LIGHTING	980	6,260		5,280	AIR HANDLER (AHU-1)	45/2	2
3	20/1	LIGHTING	603		5,883	5,280	7		4
5	20/1	RECEPTS CLS. 1/OFF. 1	1,260	3,330	$\rightarrow$	2,070	HEAT PUMP (HP-1)	30/2	6
7	20/1	RECEPTS MECH./OFF. 2	1,080		3,150	2,070	7		8
9	20/1	RECEPT TOILET	180	2,430	$\mathbb{X}$	2,250	WTR. HTR. (EWH-1) (LO)	30/2	10
11	20/1	RECEPTS TRAINING	1,260		3,510	2,250	7		12
13	20/1	DISHWASHER	1,500	1,600	$\nearrow$	100	REC. PUMP (RCP) (LO)	20/1	14
15	20/1	RECEPTS TRAINING	540	$\nearrow$	4,540	4,000	RANGE	50/2	16
17	20/1	RECEPT REFRIG.	500	4,500	$\nearrow$	4,000			18
19	20/1	RECEPTS TRAIN. FLR.	1,440	$\nearrow$	1,440				20
21	20/1	RECEPT EXTERIOR	180	180	$\langle$				22
23	20/1	RECEPT MICROWAVE	750	$\nearrow$	750				24
25	20/1	RECEPTS COUNTER	540	540	><				26
27					0				28
29				0	><				30
31					0				32
33				0					34
35					0				36
37				0					38
39					0				40
41				0	$\nearrow$				42
		CONNECTED V.A. PER P	HASE	18,840	19,273				
		TOTAL AMPERES PER P	HASE	157	161				

(LO) - DENOTES BREAKER LOCK-OUT

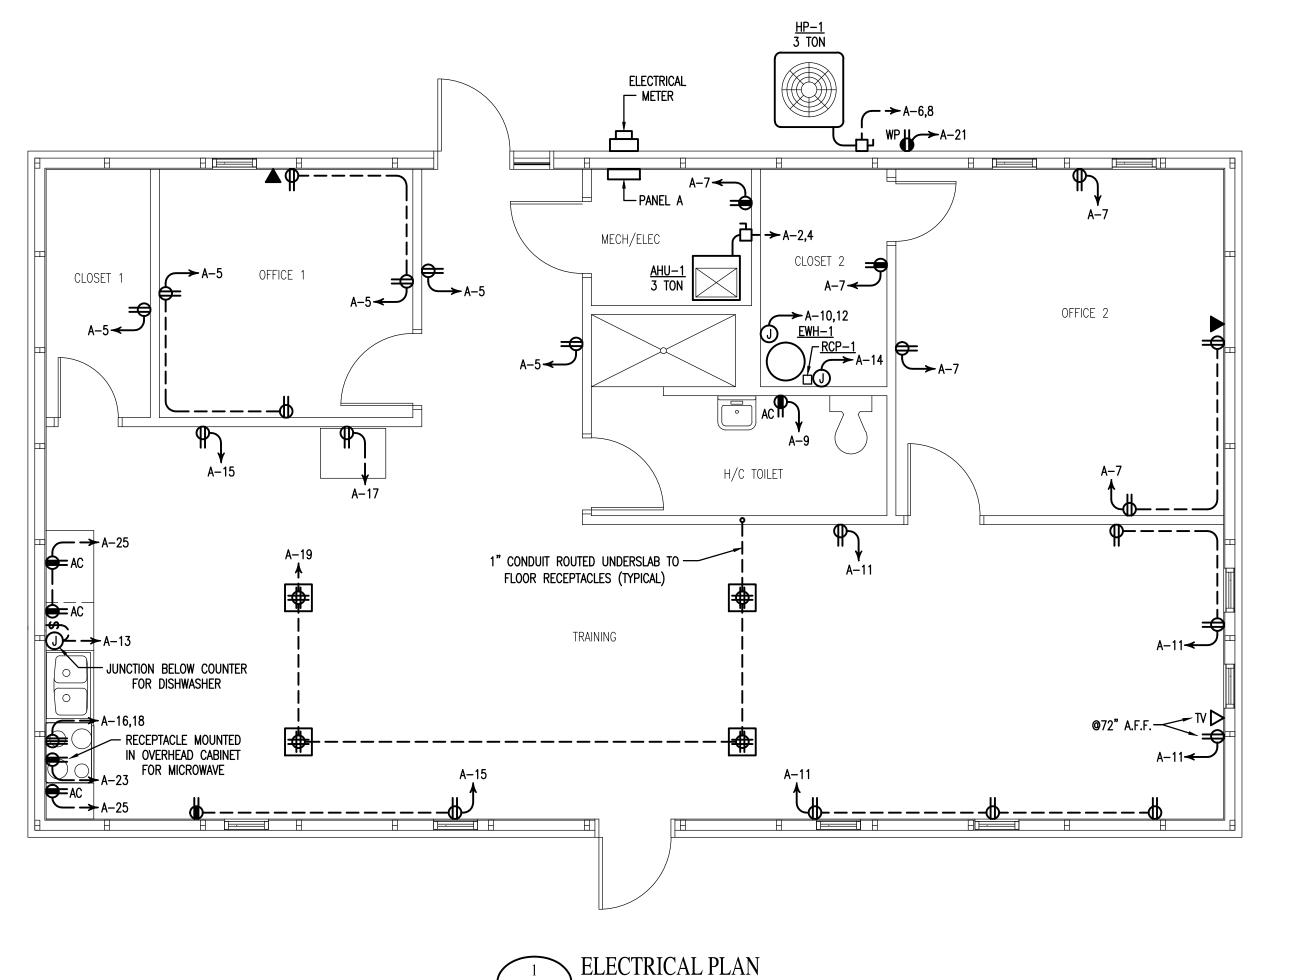

SCALE: 1/4" = 1'-0"

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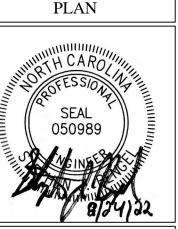
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> > GROOMS EQUIPMENT 3254 Boywood Rd. Graham, NC 27253

GROOMS EQUIPMENT TRAINING BUILDING

DRAWING NAME
ELECTRICAL



DRAWN
JNK


CHECKED
SJB

DATE
8/24/22

SCALE
AS NOTED

F-2

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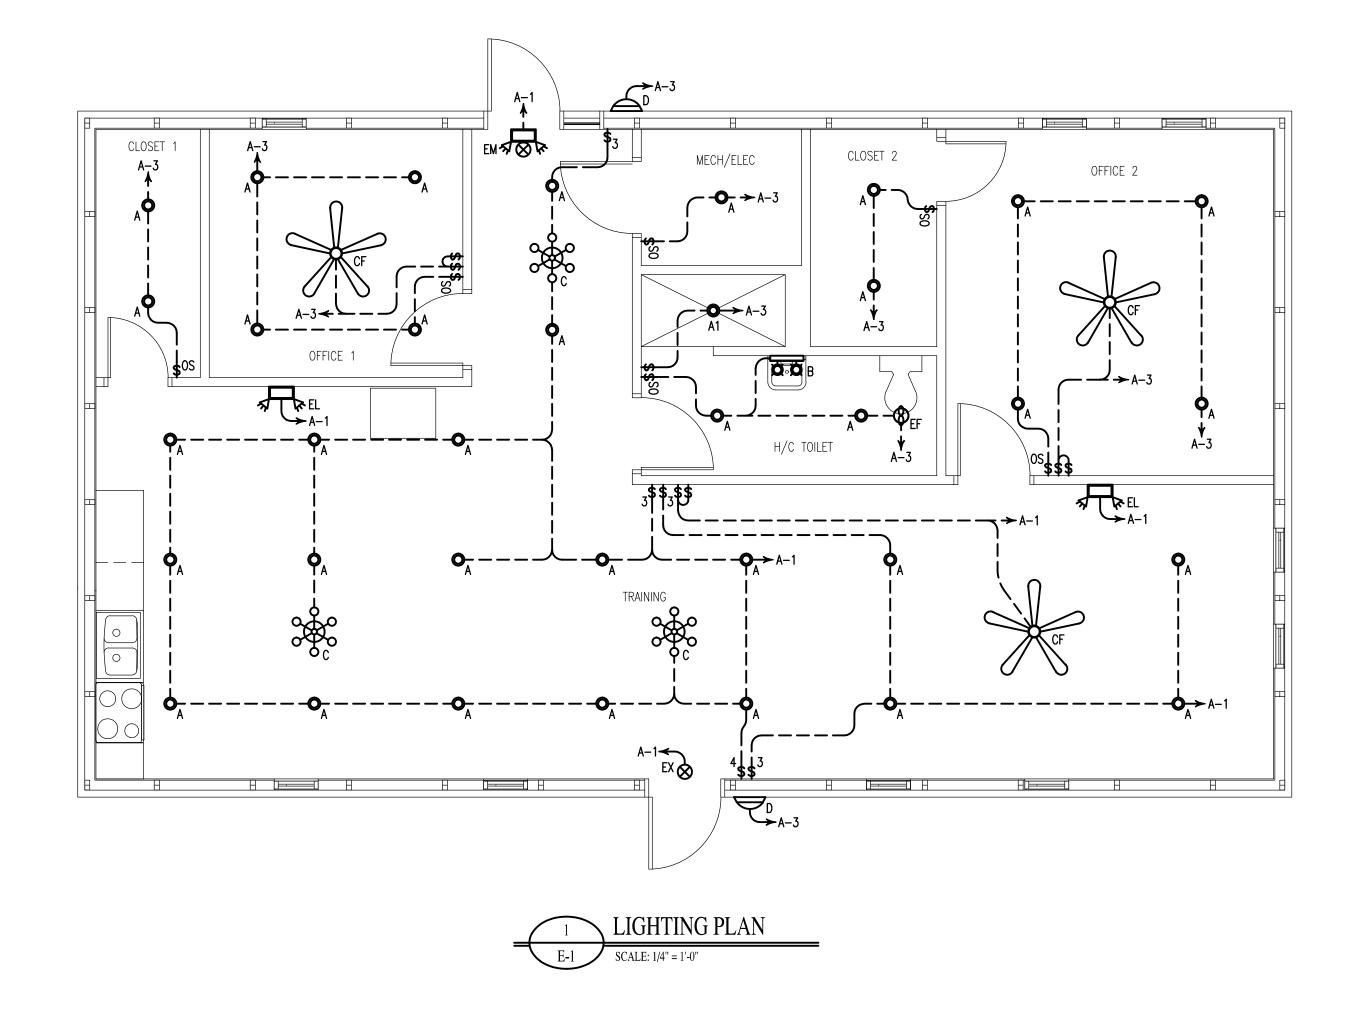


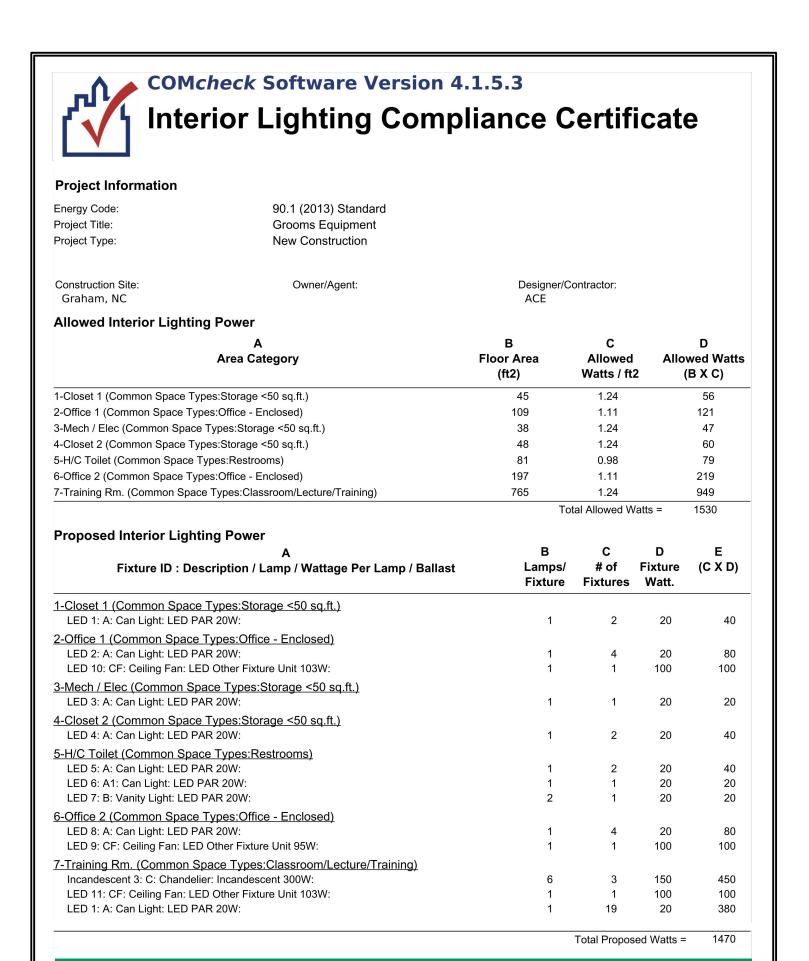Compliance Statement: The proposed interior lighting design represented in this document is consistent with the building plans, specifications, and other calculations submitted with this permit application. The proposed interior lighting systems have been designed to meet the 90.1 (2013) Standard requirements in COMcheck Version 4.1.5.3 and to comply with any applicable mandatory requirements listed in the Inspection Checklist.


nterior Lighting PASSES: Design 4% better than code

**Interior Lighting Compliance Statement** 

	LIGHTING LEGEND				
MARK	SYMBOL	SYMBOL DESCRIPTION			
A	0	RECESSED MOUNTED LED CAN LIGHT, 20W			
A1	0	RECESSED MOUNTED LED CAN LIGHT, WET LOCATION RATED, 20W			
В	00	WALL MOUNTED LED VANITY LIGHT, 20W			
С	0 0 0 0	LED CHANDELIER, 150W MAX.			
CF		52" CEILING FAN W/LED LIGHT KIT, 100W MAX.			
D		DECORATIVE EXTERIOR LED EMERGENCY LIGHT, W/HIGH-TEMPERATURE NICKEL-CADMIUM BATTERY, LITHONIA #AFF-OEL			
EF	8	BATHROOM EXHAUST FAN, SEE EXHAUST FAN SCHEDULE FOR SPECIFICATIONS			
ЕМ	<b>4⊗</b> k	LED EMERGENCY/EXIT LIGHT WITH BATTERY BACK-UP			
EL	*	LED EMERGENCY LIGHT WITH BATTERY BACK-UP			
EX	8	LED EXIT SIGN WITH BATTERY BACK—UP			
	\$	SINGLE POLE WALL SWITCH			
	<b>\$</b> 0S	LINE VOLTAGE WALL MOUNTED PIR OCCUPANCY SENSOR WITH MANUAL OVERRIDE. (30 MIN. MAX. OVERRIDE)			
		SINGLE POLE WALL SWITCHES (CEILING FAN) 1 SWITCH — FAN 1 SWITCH — LIGHT KIT			



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GROOMS EQUIPMENT

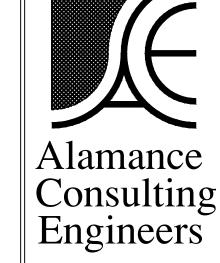GROOMS EQUIPME TRAINING BUILDIN

DRAWING NAME LIGHTING



PLAN

JNK CHECKED SJB DATE 8/24/22

SCALE AS NOTED

22052