- 1	
	TZ67 TO CAROLINIA DRAWN
- 1	DRAWN

 DRAWN	
MMM	
CHECKED	
MMM	
DATE	
8/24/22	
SCALE	
AS NOTED	
 JOB NO.	
22052	

2018 APPENDIX B BUILDING CODE SUMMARY FOR ALL COMMERCIAL PROJECTS (EXCEPT 1 AND 2-FAMILY DWELLINGS AND TOWNHOUSES) (Reproduce the following data on the building plans sheet 1 or 2)

Name of Project: GROOMS EQUIPMENT	STORAGE & TRAINING BU	ILDING
Address: 3254 Boywood Rd, Graham NC		Zip Code <u>27253</u>
Owner/Authorized Agent: Charles Sedoris	Phone # (<u>336</u>) <u>603</u> – <u>8029</u>	E-Mail charles@groomsequipment.com
Owned By: Private		
Code Enforcement Jurisdiction: County		

DESIGNER	FIRM	NAME	LICENSE#	TELEPHONE#	E-MAIL
Architectural	Martha Mason Architect	MMMason AIA	7267	(336) 684-1021	
Civil					
Electrical	Alam Consult Engineers	SJBengel PE	050989	(336)449-4558	
Fire Alarm				()	
Plumbing	Alam Consult Engineers	SJBengel PE	050989	(336)449-4558	
Mechanical	Alam Consult Engineers	SJBengel PE	050989	(336)449-4558	
Sprinkler-Stand	lpipe			()	
Structural				()	
Retaining Wall	s >5' High			()	
Other	_			()	

2018 NC BUILDING CODE: New Building

2018 NC EXISTING BUILDING CODE: Select one Select one Select one CONSTRUCTED: (date) CURRENT OCCUPANCY(S) (Ch. 3): RENOVATED: (date) PROPOSED OCCUPANCY(S) (Ch. 3): RISK CATEGORY (Table 1604.5): Current: II Proposed: [[

BASIC BUILDING DATA Construction Type: V-B Sprinklers: No Select one Standpipes: No Primary Fire District: No

Flood Hazard Area: No

1400

1400

ALLOWABLE AREA

Special Inspections Required: No

Mezzanine

Basement

1st Floor

Gro	ss Building Area Table	
T)	NEW (SQ FT)	Sub-Total

1400

1400

ALLOWABLE AREA PER

CODE REFERENCE 1

STORY OR UNLIMITED^{2,3}

Select one Select one Select one

TABLE 506.24 AREA FOR FRONTAGE

SHOWN ON PLANS

13'-0"

AREA INCREASE^{1,5}

2018 NC Administrative Code and Policies

Primary Occupancy Classification(s): Storage - S-2

Special Provisions: (Chapter 5 – List Code Sections):

Mixed Occupancy: Select one Separation: Select one Exception:

Actual Area of Occupancy A + Actual Area of Occupancy B < 1

a. Perimeter which fronts a public way or open space having 20 feet minimum width = _____(F)

ALLOWABLE HEIGHT

40'

Allowable Area of Occupancy A Allowable Area of Occupancy B

BLDG AREA PER

e. Percent of frontage increase $I_f = 100[F/P - 0.25] \times W/30 =$ _____(%)

⁴ The maximum area of open parking garages must comply with Table 406.5.4.

⁵ Frontage increase is based on the unsprinklered area value in Table 506.2.

³ Maximum Building Area = total number of stories in the building x D (maximum 3 stories) (506.2).

¹ Provide code reference if the "Shown on Plans" quantity is not based on Table 504.3 or 504.4.

² The maximum height of air traffic control towers must comply with Table 412.3.1.

³ The maximum height of open parking garages must comply with Table 406.5.4.

STORY (ACTUAL)

Accessory Occupancy Classification(s):

Special Uses (Chapter 4 – List Code Sections):

DESCRIPTION AND

¹ Frontage area increases from Section 506.3 are computed thus:

b. Total Building Perimeter = _____(P)
c. Ratio (F/P) = _____(F/P)
d. W = Minimum width of public way = _____(W)

² Unlimited area applicable under conditions of Section 507.

Incidental Uses (Table 509):

Select one

FIRE PROTECTION REQUIREMENTS

BUILDING ELEMENT	FIRE		RATING	DETAIL#	DESIGN#	SHEET # FOR	SHEET #
	SEPARATION	REQ'D	PROVIDED *	AND SHEET#	FOR	RATED	FOR
	DISTANCE (FEET)		REDUCTION)	SHEET#	RATED ASSEMBLY	PENETRATION	RATED JOINTS
Structural Frame,							
including columns, girders,		N/A					
trusses							
Bearing Walls							
Exterior							
North		0	0				
East		0	0				
West		0	0				
South		0	0				
Interior		N/A					
Nonbearing Walls and Partitions							
Exterior walls							
North		N/A					
East		N/A					
West		N/A					
South		N/A					
Interior walls and partitions		0	0				
Floor Construction							
Including supporting beams		N/A					
and joists		19/74					
Floor Ceiling Assembly		0	0				
Columns Supporting Floors		N/A					
Roof Construction, including							
supporting beams and joists		0	0				
Roof Ceiling Assembly		0	0				
Columns Supporting Roof		N/A					
Shaft Enclosures - Exit		N/A					
Shaft Enclosures - Other		N/A					
Corridor Separation		N/A					
Occupancy/Fire Barrier S	Separation	N/A N/A					
Party/Fire Wall Separation							
Smoke Barrier Separation		N/A					
Smoke Partition		N/A					
Tenant/Dwelling Unit/ Sleeping Unit Separation		N/A					
Incidental Use Separation		N/A					

2018 NC Administrative Code and Policies

PERCENTAGE OF WALL OPENING CALCULATIONS

Fire Separation Distance (Feet) from Property lines	Degree of openings Protection (Table 705.8)	Allowable area (%)	ACTUAL SHOWN ON PLANS (%)
>30'	No limit	No limit	No limit

	LIFE
Emergency Lighting:	Yes
Exit Signs:	Yes
Fire Alarm:	No
Smoke Detection Systems:	No
Carbon Monoxide Detection:	No

LIFE SAFETY PLAN REQUIREMENTS

Life Safety Plan Sheet #: A-1

- Fire and/or smoke rated wall locations (Chapter 7)
- Exterior wall opening area with respect to distance to assumed property lines (705.8)
- ☑ Common path of travel distances (Tables 1006.2.1 & 1006.3.2(1))
- Dead end lengths (1020.4)
- Clear exit widths for each exit door
- Actual occupant load for each exit door
- purposes of occupancy separation
- Location of doors with delayed egress locks and the amount of delay (1010.1.9.7)
- Location of doors with electromagnetic egress locks (1010.1.9.9)
- Location of doors equipped with hold-open devices
- The square footage of each fire area (202)

FIRE SEPARATION DISTANCE (FEET) FROM PROPERTY LINES	Degree of openings Protection (Table 705.8)	Allowable area (%)	ACTUAL SHOWN ON PLANS (%)
>30'	No limit	No limit	No limit

E SAFETY SYSTEM REQUIREMENTS

	LIFE
Emergency Lighting:	Yes
Exit Signs:	Yes
Fire Alarm:	No
Smoke Detection Systems:	No
Carbon Monovide Detection:	No

- Assumed and real property line locations (if not on the site plan)
- Occupancy Use for each area as it relates to occupant load calculation (Table 1004.1.2)
- Occupant loads for each area
- Exit access travel distances (1017)

- Maximum calculated occupant load capacity each exit door can accommodate based on egress width (1005.3)
- A separate schematic plan indicating where fire rated floor/ceiling and/or roof structure is provided for
- ✓ Location of doors with panic hardware (1010.1.10)
- Location of emergency escape windows (1030)
- The square footage of each smoke compartment for Occupancy Classification I-2 (407.5)
- Note any code exceptions or table notes that may have been utilized regarding the items above

2018 NC Administrative Code and Policies

Building Height in Feet (Table 504.3) ²

Building Height in Stories (Table 504.4)³

2018 NC Administrative Code and Policies

2018 NC Administrative Code and Policies

ENERGY SUMMARY The following data shall be considered minimum and any special attribute required to meet the energy code shall

also be provided. Each Designer shall furnish the required portions of the project information for the plan data sheet. If performance method, state the annual energy cost for the standard reference design vs annual energy cost for the proposed design.

ACCESSIBLE DWELLING UNITS

(SECTION 1107)

ACCESSIBLE PARKING (SECTION 1106)

PLUMBING FIXTURE REQUIREMENTS (TABLE 2902.1)

REQ'D 0 0 1 0 0 1 0 0

SPECIAL APPROVALS

Special approval: (Local Jurisdiction, Department of Insurance, OSC, DPI, DHHS, etc., describe below)

UNITS

PROVIDED REGULAR WITH

OTAL ACCESSIBLE ACCESSIBLE

LOT OR PARKING TOTAL # OF PARKING SPACES

Units

Units

TYPE A

Units

TYPE B

UNITS

OF ACCESSIBLE SPACES PROVIDED

5' ACCESS AISLE 132" ACCESS 8' ACCESS

VAN SPACES WITH

Units

ACCESSIBLE UNITS PROVIDED

ACCESSIBLE

PROVIDED

Existing building envelope complies with code: Select one

2018 NC Administrative Code and Policies

ENERGY REQUIREMENTS:

Exempt Building: Yes Provide code or statutory reference: Section C101.2 exception 2, NCSEC

Climate Zone: Select one Method of Compliance: Select one

(If "Other" specify source here)___ THERMAL ENVELOPE (Prescriptive method only)

Roof/ceiling Assembly (each assembly) Description of assembly:

U-Value of total assembly: R-Value of insulation: Skylights in each assembly: U-Value of skylight:

total square footage of skylights in each assembly: Exterior Walls (each assembly)

Description of assembly: U-Value of total assembly: R-Value of insulation:

Openings (windows or doors with glazing) U-Value of assembly: Solar heat gain coefficient:

projection factor: Door R-Values: Walls below grade (each assembly) Description of assembly:

U-Value of total assembly: R-Value of insulation:

Floors over unconditioned space (each assembly) Description of assembly: U-Value of total assembly: R-Value of insulation:

Floors slab on grade

Description of assembly: U-Value of total assembly: R-Value of insulation: Horizontal/vertical requirement: slab heated:

GR(


EQUIPMENT G BUILDING

Architect

Martha Mason

GROOMS EQUIPMENT
3254 Boywood Rd.

DRAWING NAME
APPENDIX 'B'
(2 OF 2)

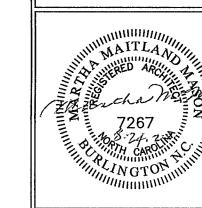

MMM
CHECKED
MMM
DATE
8/24/22

8/24/22 SCALE AS NOTED JOB NO. 22052

G-2

2018 NC Administrative Code and Policies


Size category. If oversized, state reason.:

Refer to Mechanical Drawings

List equipment efficiencies:


GENERAL NOTES:


- I. ALL FLAT CEILINGS TO BE PAINTED GWB @ 8'-0" AFF
- 2. PRIOR TO PLACING SOG, CONFIRM FLOOR FINISHES W/OWNER TYP
- 3. PROVIDE SOUND INSULATION IN CAVITY OF ALL INTERIOR WALLS
- 4. PROVIDE PRIVACY LOCK @ TOILET ROOM DOOR
- 5. ALL DOORS TO BE PROVIDED BY OWNER. DOOR SIZES ARE 3'-O" X 6'-8"
- G. ALL WINDOWS TO BE PROVIDED BY OWNER; CONFIRM SIZES PRIOR TO FRAMING EXTERIOR WALLS
- 7. ALL EXTERIOR WINDOWS TO BE DOUBLE PANE W/ LOW-E COATING
- 8. ALTHOUGH STORAGE OCCUPANCIES DO NOT REQUIRE IT, THERMAL INSULATION SHALL BE INSTALLED AS NOTED ON THE DRAWINGS

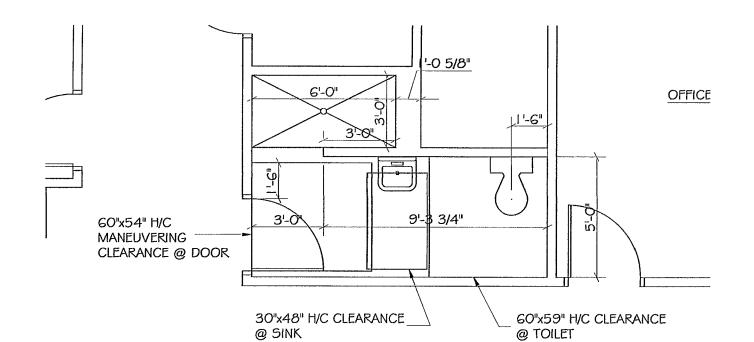


H/C TOILET/SHOWER PLAN

SCALE: 1/4" = 1'-0"

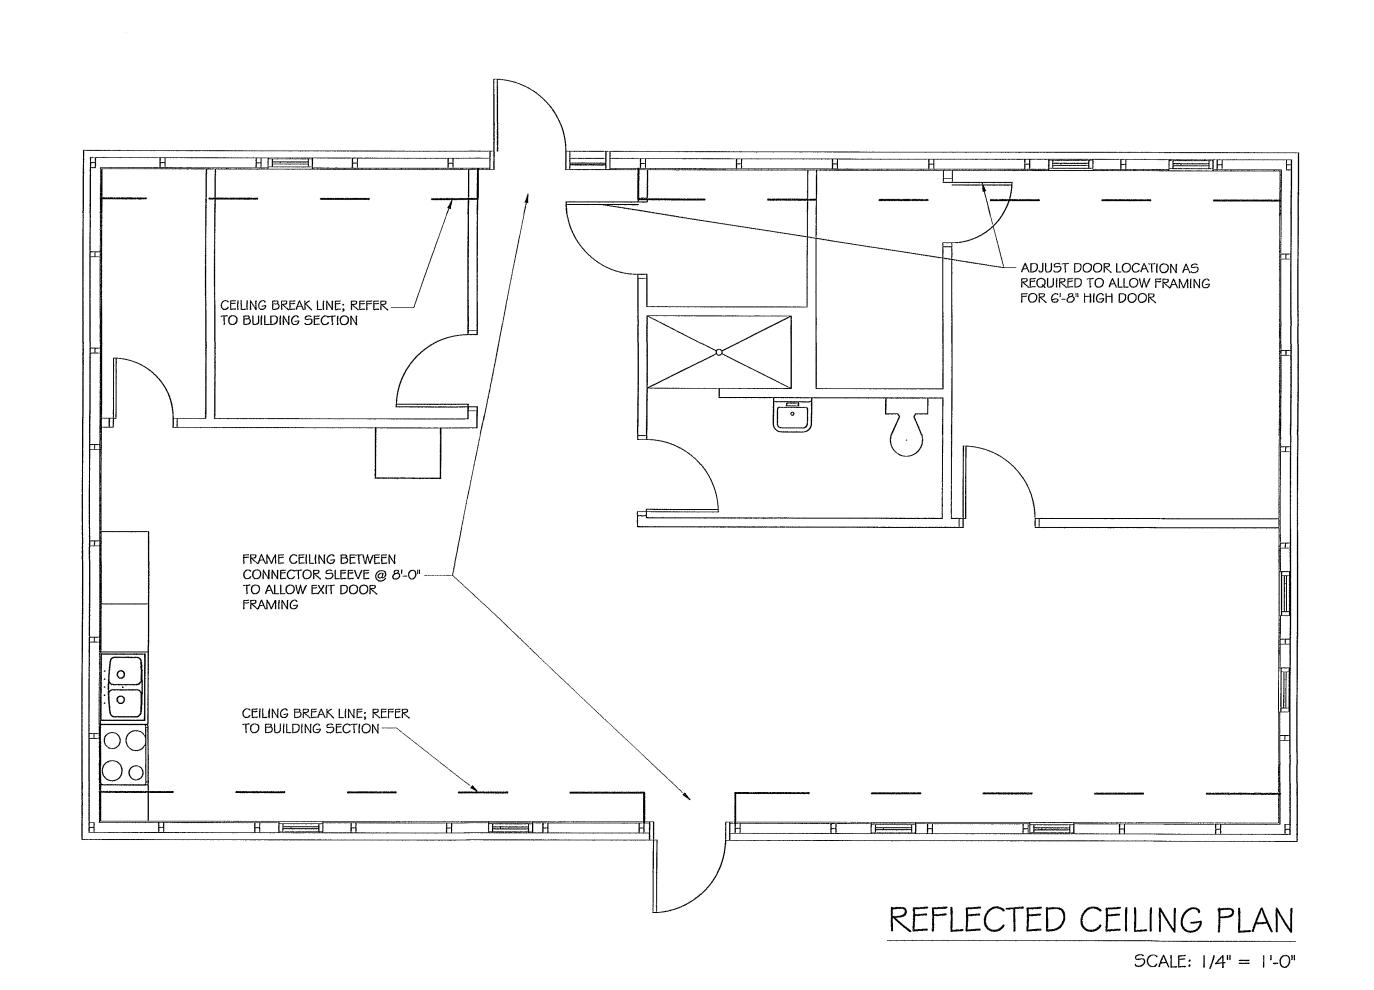

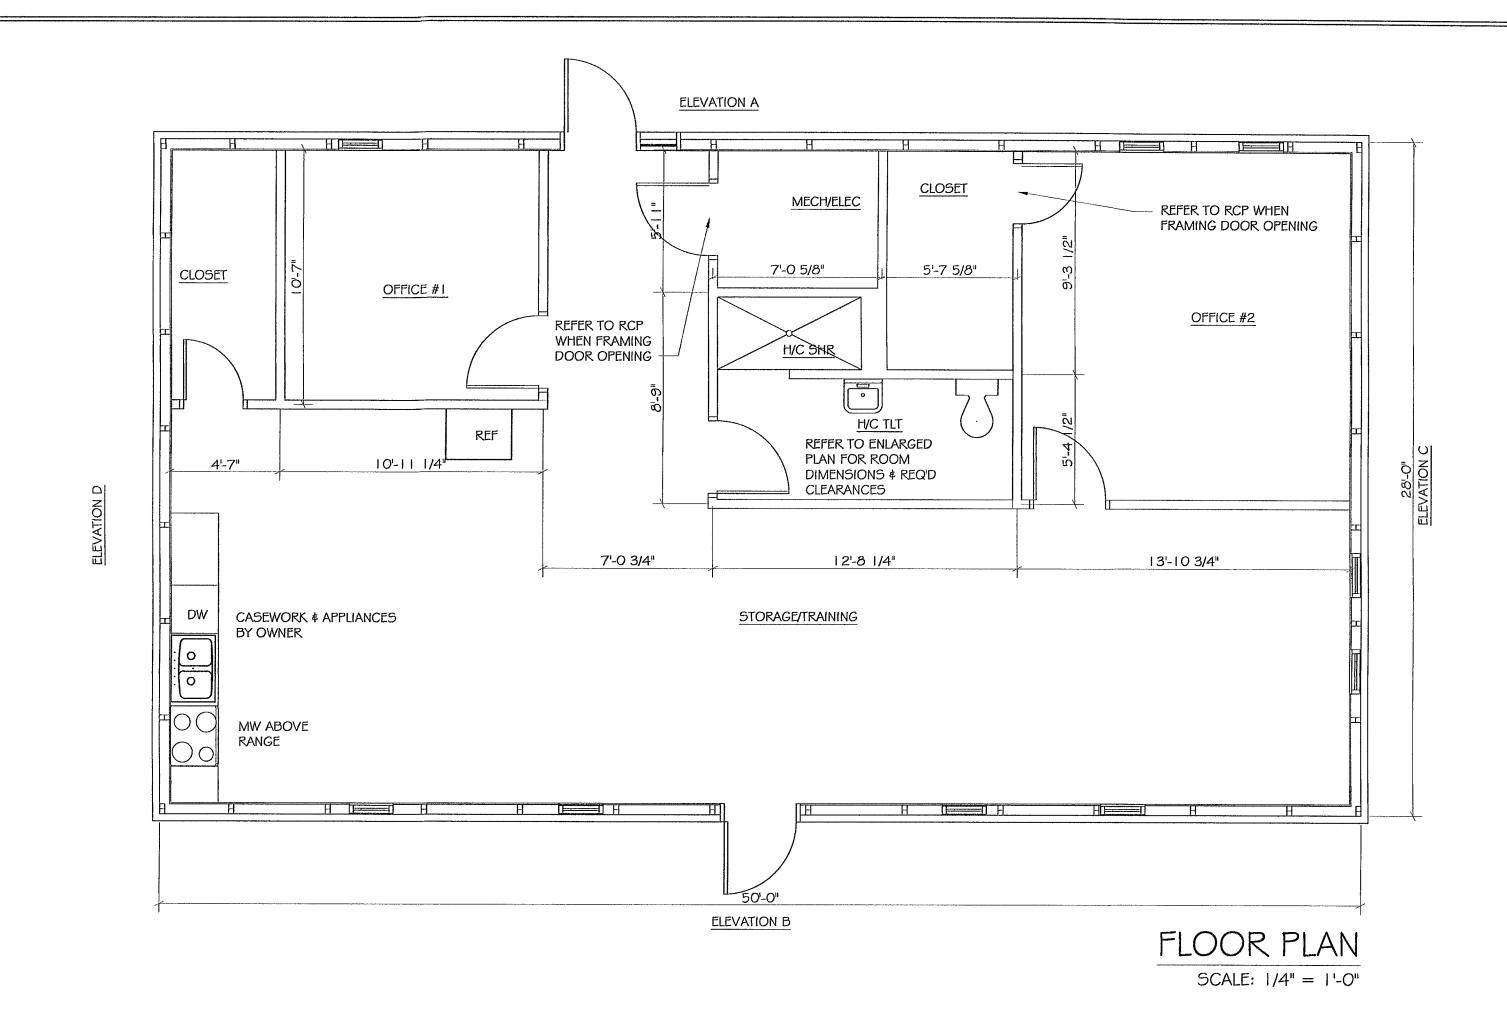

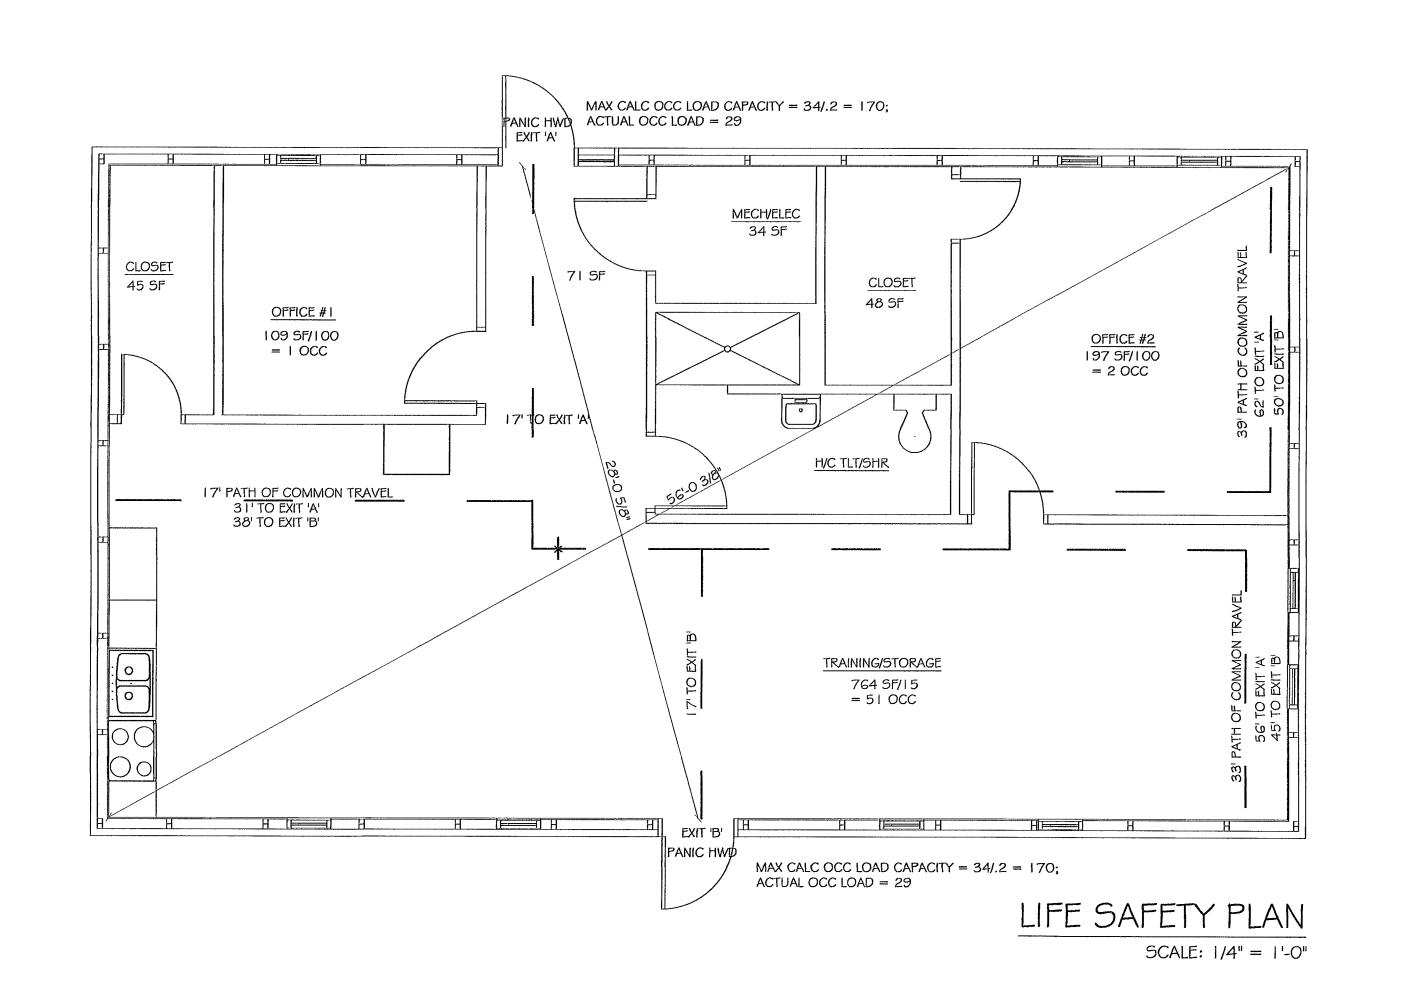

NT Martha Mason Architect

GROOMS EQUIPMENT
3254 Boywood Rd.
Graham, NC 27253

GROOMS EQUIPMENT
TRAINING BUILDING
Graham, North Carolina

DRAWING NAME
LS, FLOOR, RC PLANS
H/C TOILET/SHR PLAN

TZ67

TZ67

DRAWN

MMM

DRAWN
MMM

CHECKED
MMM

DATE

8/24/22

SCALE

AS NOTED

JOB NO.


22052

A- |

METAL ROOF -METAL SIDING -WINDOW AS SELECTED BY OWNER, TYP. 3'-0" X 6'-8" DOOR SELECTED BY OWNER -ELEVATION A


2-2.5"X2.5" TS COLS WINAILER 2X6 WD STUD FRAMING -5/8" GWB -1/2" EXT SHEATHING-/ (SIDING NOT SHOWN) PLAN DETAIL SCALE: 1/4" = 1'-0"

SCALE: 1/4" = 1'-0"

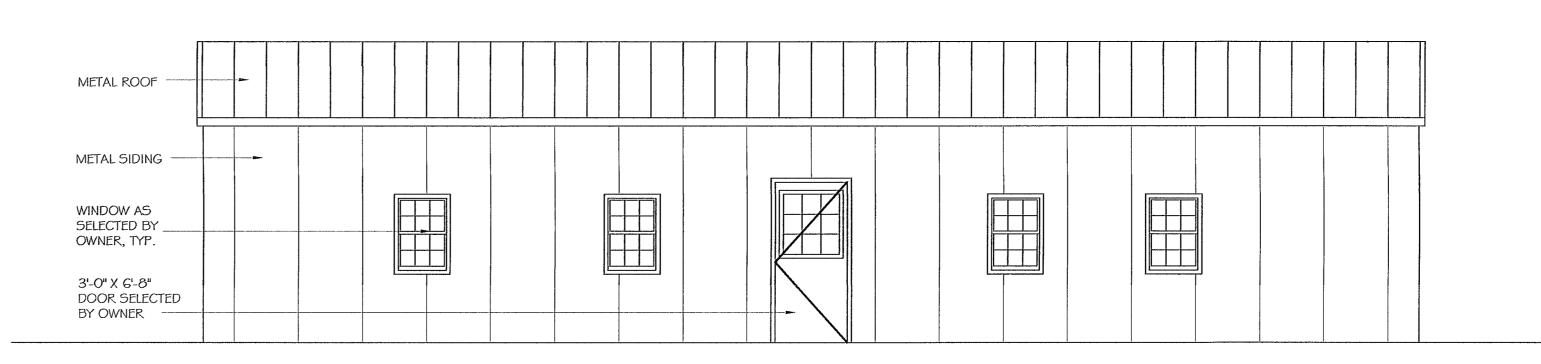


ELEVATION B SCALE: 1/4" = 1'-0"

SCALE: 1/4" = 1'-0"

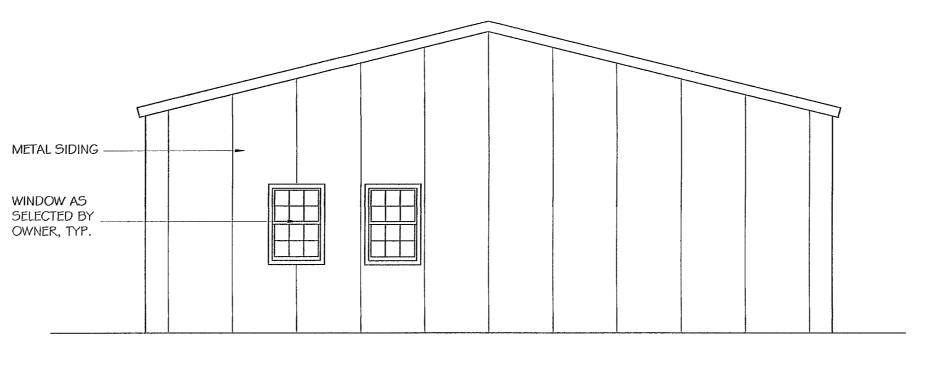

ELEVATION C SCALE: 1/4" = 1'-0"

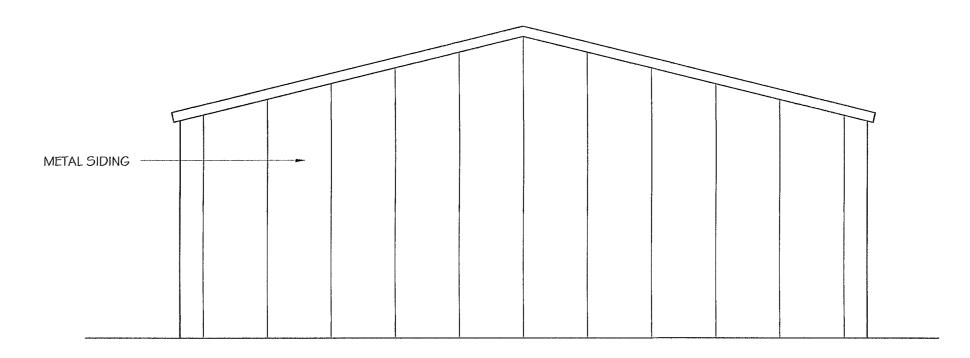


ELEVATION D SCALE: 1/4" = 1'-0"

Architect Martha Mason

GROOMS EQUIPMENT TRAINING BUILDIN

DRAWING NAME
ELEVATIONS, WALL
SECTION & DETAIL

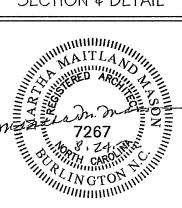

drawn **MMM** CHECKED MMM DATE 8/24/22 SCALE AS NOTED JOB NO. 22052