CONSTRUCTION DOCUMENTS ALAMANCE - BURLINGTON SCHOOL SYSTEM

2022 SECURITY VESTIBULES

HAW RIVER ELEM.

DESIGN TEAM					
ARCHITECT	ELECTRICAL & MECHANICAL				
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INDEX OF DRAWINGS

DISCIPLINE

ARCHITECTURAL

CS100 COVER SHEET
LS100 LIFE SAFETY PLANS, PARTITION TYPES, AND DETAILS
A200 DEMO & FLOOR PLANS
A1200 DOOR SCHEDULE & DETAILS

FINISH PLAN, LEGEND, SCHEDULE, AND DETAILS

MECHANICAL & ELECTRICAL


M101 MECHANICAL PLANS, NOTES AND SCHEDULES

E001 ELECTRICAL SYMBOLS, NOTES AND SPECIFICATIONS
E101 ELECTRICAL FLOOR PLANS AND SCHEDULE

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CONSTRUCTION

UE DATE: 02/24/22

REVISIONS

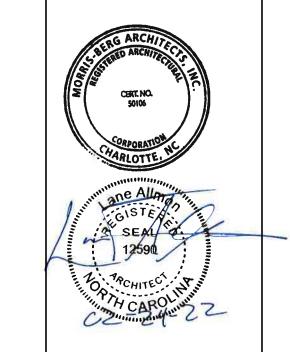NO. DATE

ALAMANCE - BURLINGTON SCHOOL SYSTI



PROJECT NUMBER 2111


SHEET TITLE
COVER SHEET
SHEET NUMBER


CS100

EXISTING EGRESS CAPACITY IS NOT BEING ALTERED AS PART OF THE SCHOOL VESTIBULE PROJECT. NO CHANGE IN USE OR OCCUPANCY IS PART OF THIS PROJECT.

LEGEND


2225 ◀ ROOM NUMBER CLASSROOM- ROOM NAME 995 SF **→** ROOM SQUARE FOOTAGE ACCESSIBLE ENTRANCE/EXIT **Morris**·Berg A R C H I T E C T S
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CONSTRUCTION **DOCUMENTS**

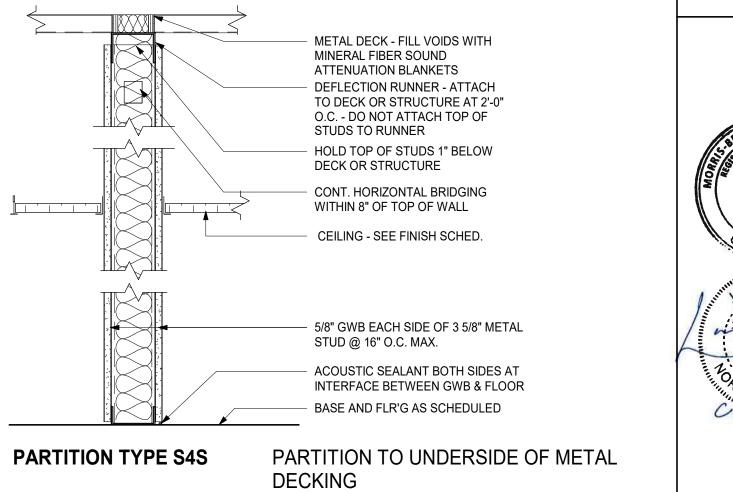ISSUE DATE: **REVISIONS**

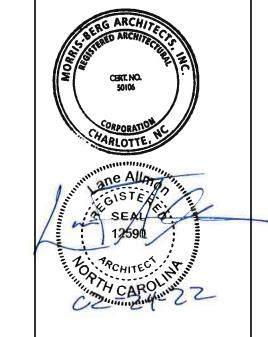

FIRST FLOOR PLAN - LIFE SAFETY PLAN

1/4" = 1'-0"

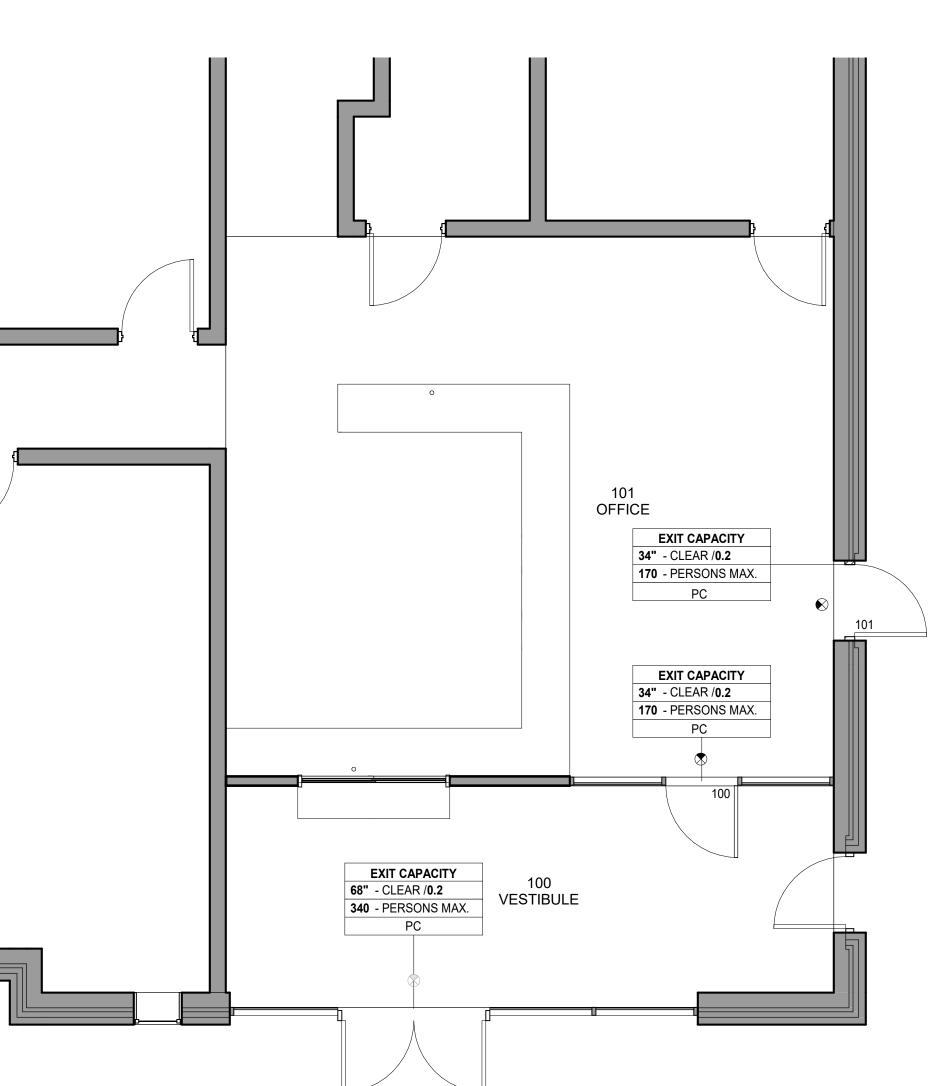
ALAMANCE - BURLINGTON SCHOOL SYSTEM 2022 SECURITY VESTIBULES 2022 SECURITY NHAW RIVER BLEM.

SHEET TITLE
LIFE SAFETY PLANS,
PARTITION TYPES, AND

LS100

HAW RIVER

DETAILS SHEET NUMBER

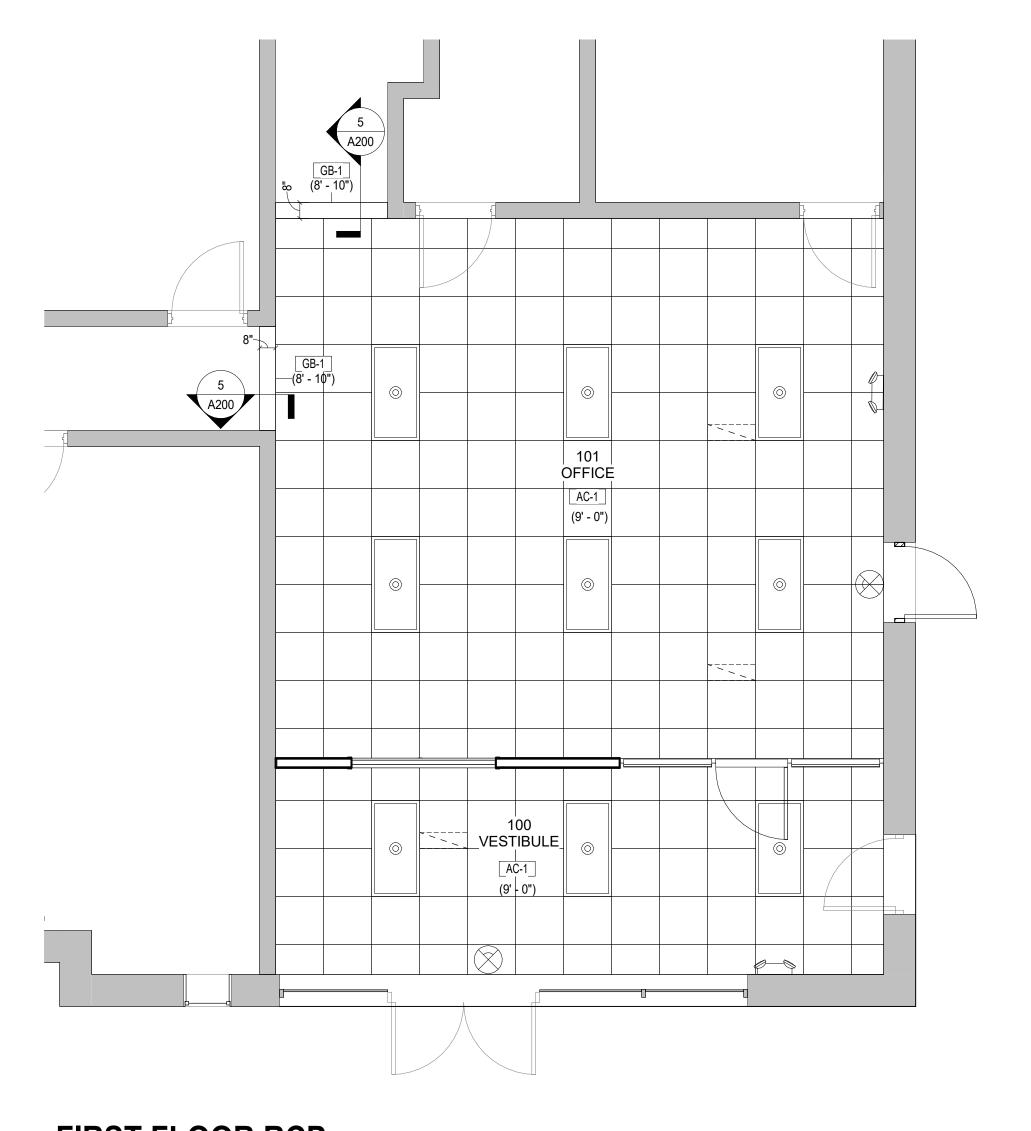

• DW-07 DE-02 DE-01

SYMBOL LEGEND

SIM DRAWING NUMBER
SHEET NUMBER SECTION TAG DETAIL TAG 1 DRAWING NUMBER
SHEET NUMBER


PARTITION TAG PARTITION TYPE (SEE SHEET LS300)


KEYED NOTE ?

> MILLWORK/ELEVATION TAG DRAWING NUMBER ELEVATION LETTER

RELOCATED SUPPLY - SEE MECH.

SHEET NUMBER

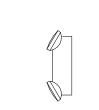

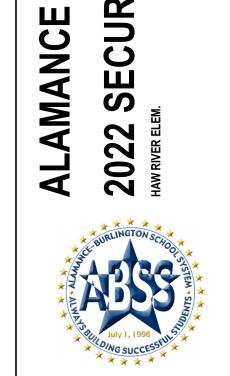

PROJECT NUMBER SHEET TITLE
DEMO & FLOOR PLANS

SHEET NUMBER A200

HAW RIVER

FIRST FLOOR RCP

1/4" = 1'-0"

- 3 5/8" STUDS @ 16" O.C. TO STRUCTURE

KICKER AS REQUIRED


- EXISTING CEILING

SECTION THRU GWB BULKHEAD1" = 1'-0"

SEE RCP


5/8" GYSPUM WALLBOARD

CEILING - SEE RCP FOR HEIGHT

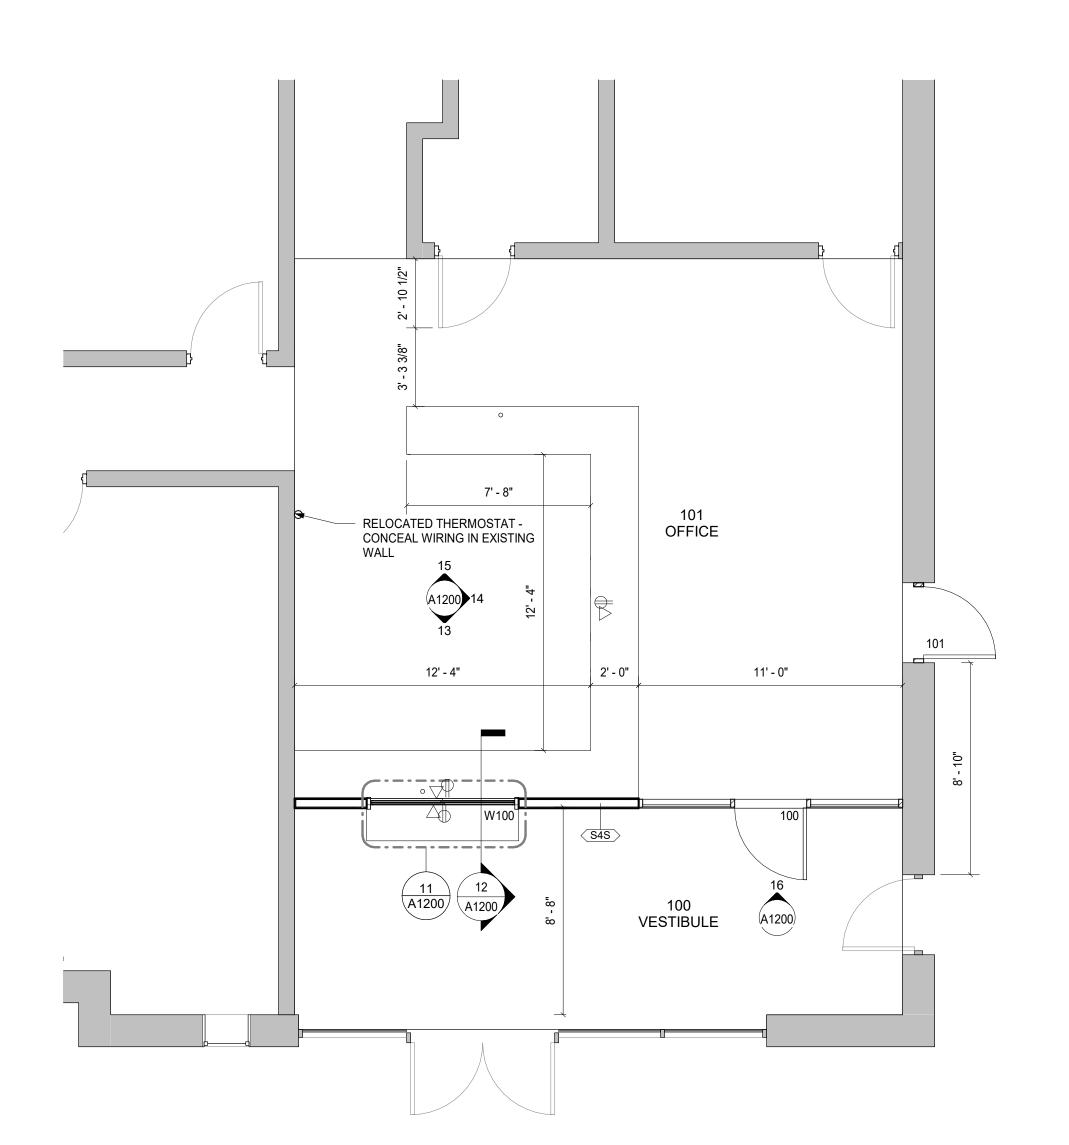

FIRST FLOOR PLAN - NEW WORK SEE A1400 FOR NEW FLOOR FINISHES

1/4" = 1'-0"

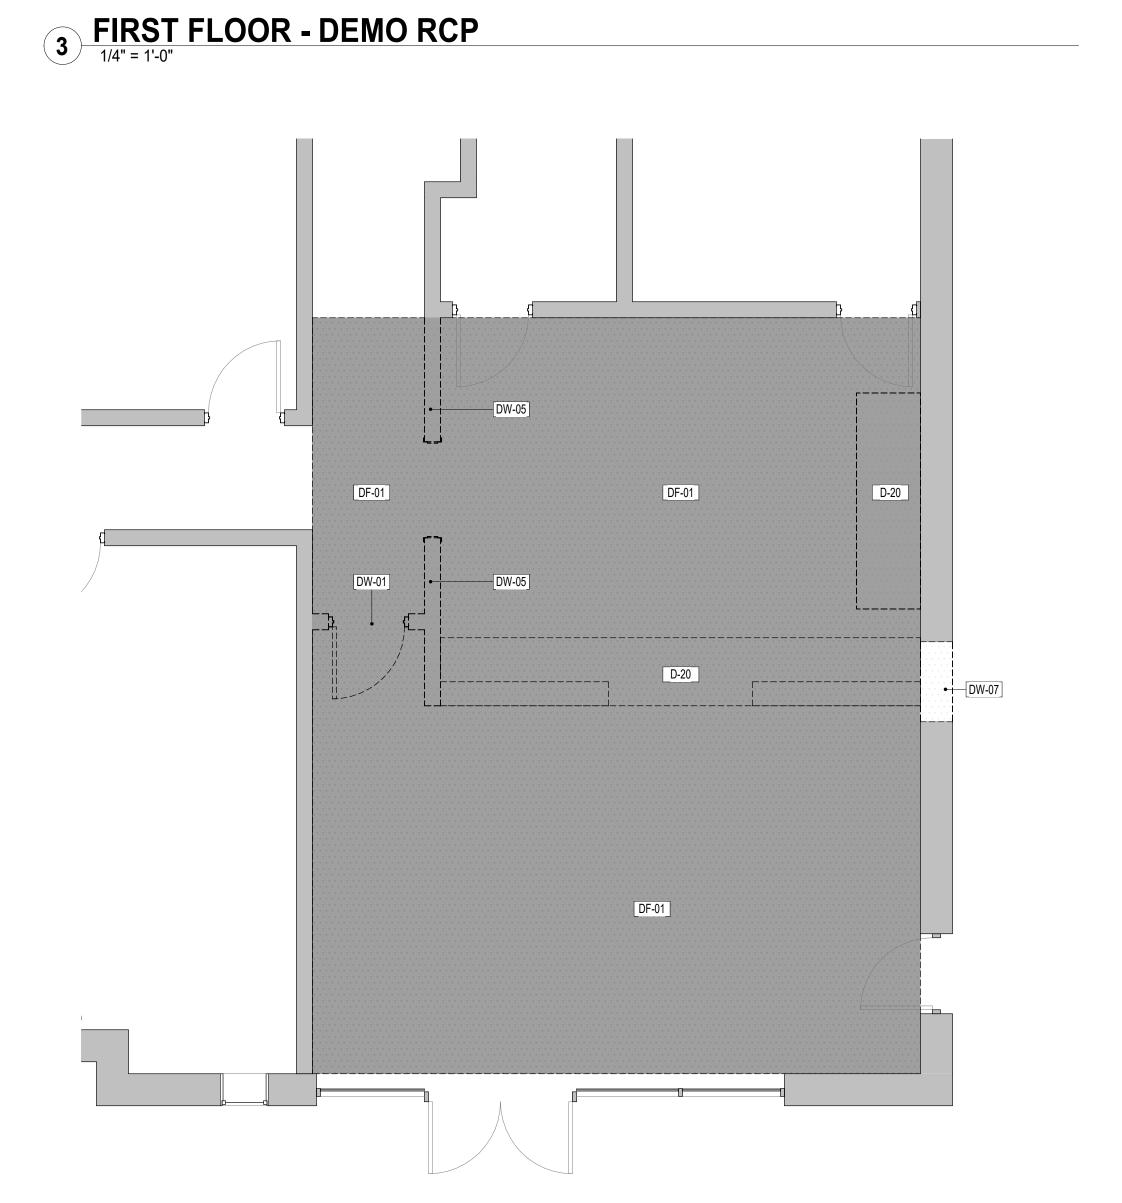

1 FIRST FLOOR PLAN - DEMO

KEYNOTES

OPENING)

SEE SPEC SECTION 095113 GB-1: GYPSUM BOARD FOR GWB CEILINGS,

RECEIVE NEW FINISHES.

1/4" ANGLE 8" BEARING EACH SIDE OF

GENERAL NOTES

DIMENSIONS SHALL BE FIELD VERIFIED BY THE

WORK.

A. DO NOT SCALE DRAWING. CONTRACTOR SHALL RELY ON WRITTEN DIMENSIONS AS SHOWN. THE CONTRACTOR

SHALL NOTIFY THE ARCHITECT FOR CLARIFICATION. ALL

CONTRACTOR AND COORDINATED WITH ALL OF THE WORK OF ALL TRADES. IF DISCREPANCIES ARE FOUND, THE GENERAL CONTRACTOR SHALL NOTIFY THE ARCHITECT IN WRITING FOR CLARIFICATION BEFORE STARTING THE

KEYNOTES - DEMO

NEW FLOOR AND WALL FINISHES.

CEILING SYSTEM

CEILING SYSTEM.

DEMO BUILT-IN CASEWORK IN ITS ENTIRETY. PATCH FLOOR AND WALLS AS NEEDED FOR

REMOVE SHADED PORTION OF EXISTING CEILING IN ITS ENTIRETY. COORDINATE WITH ELECT. AND MECH. CONTRACTORS FOR REMOVAL OF LIGHT FIXTURES, DIFFUSERS,

EXISTING EXIT SIGN TO BE REMOVED BY ELECTRICAL CONTRACTOR - COORDINATE WORK WITH THE REMOVAL OF THE EXISTING

EXISTING LIGHT FIXTURES TO BE REMOVED BY ELECTRICAL CONTRACTOR. COORDINATE WORK WITH THE REMOVAL OF THE EXISTING

REMOVE SHADED PORTION OF EXISTING FLOOR FINISH IN ITS ENTIRETY TO

SUBFLOOR - PATCH SUBFLOOR AS NECESSARY TO RECEIVE NEW FINISHES REMOVE EXISTING WALL IN ITS ENTIRETY INCLUDING ANY DOORS, FRAMES, WINDOWS, LOUVERS, ETC. PATCH WALLS AND FLOORS AS NECESSARY. COORDINATE WITH THE WORK OF OTHER CONTRACTORS. REMOVE PORTION OF EXISTING WALL IN ITS ENTIRETY. PATCH FLOOR AND ADJACENT WALLS TO REMAIN AS NECESSARY TO REMOVE PORTION OF EXISTING WALL FOR NEW OPENING AS SHOWN - PROVIDE NEW LOOSE LINTEL AT EXTERIOR BRICK (3" X 5"X

SYSTEM

BURLINGTON SCHOOL

VESTIBULE

SECURITY

REVISIONS

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CONSTRUCTION **DOCUMENTS**


ISSUE DATE: 02/24/22 ACOUSTIC PANEL CEILING, (AC-1, 3/4" X 24" X 24") HEADERS, AND SOFFITS. SEE SPEC SECTION 09




NEW EXIT SIGN - SEE ELECT.




NEW 2' x 4' LIGHT FIXTURES - SEE ELECT.

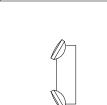

NEW EMERGENCY LIGHT FIXTURE - SEE ELECT.

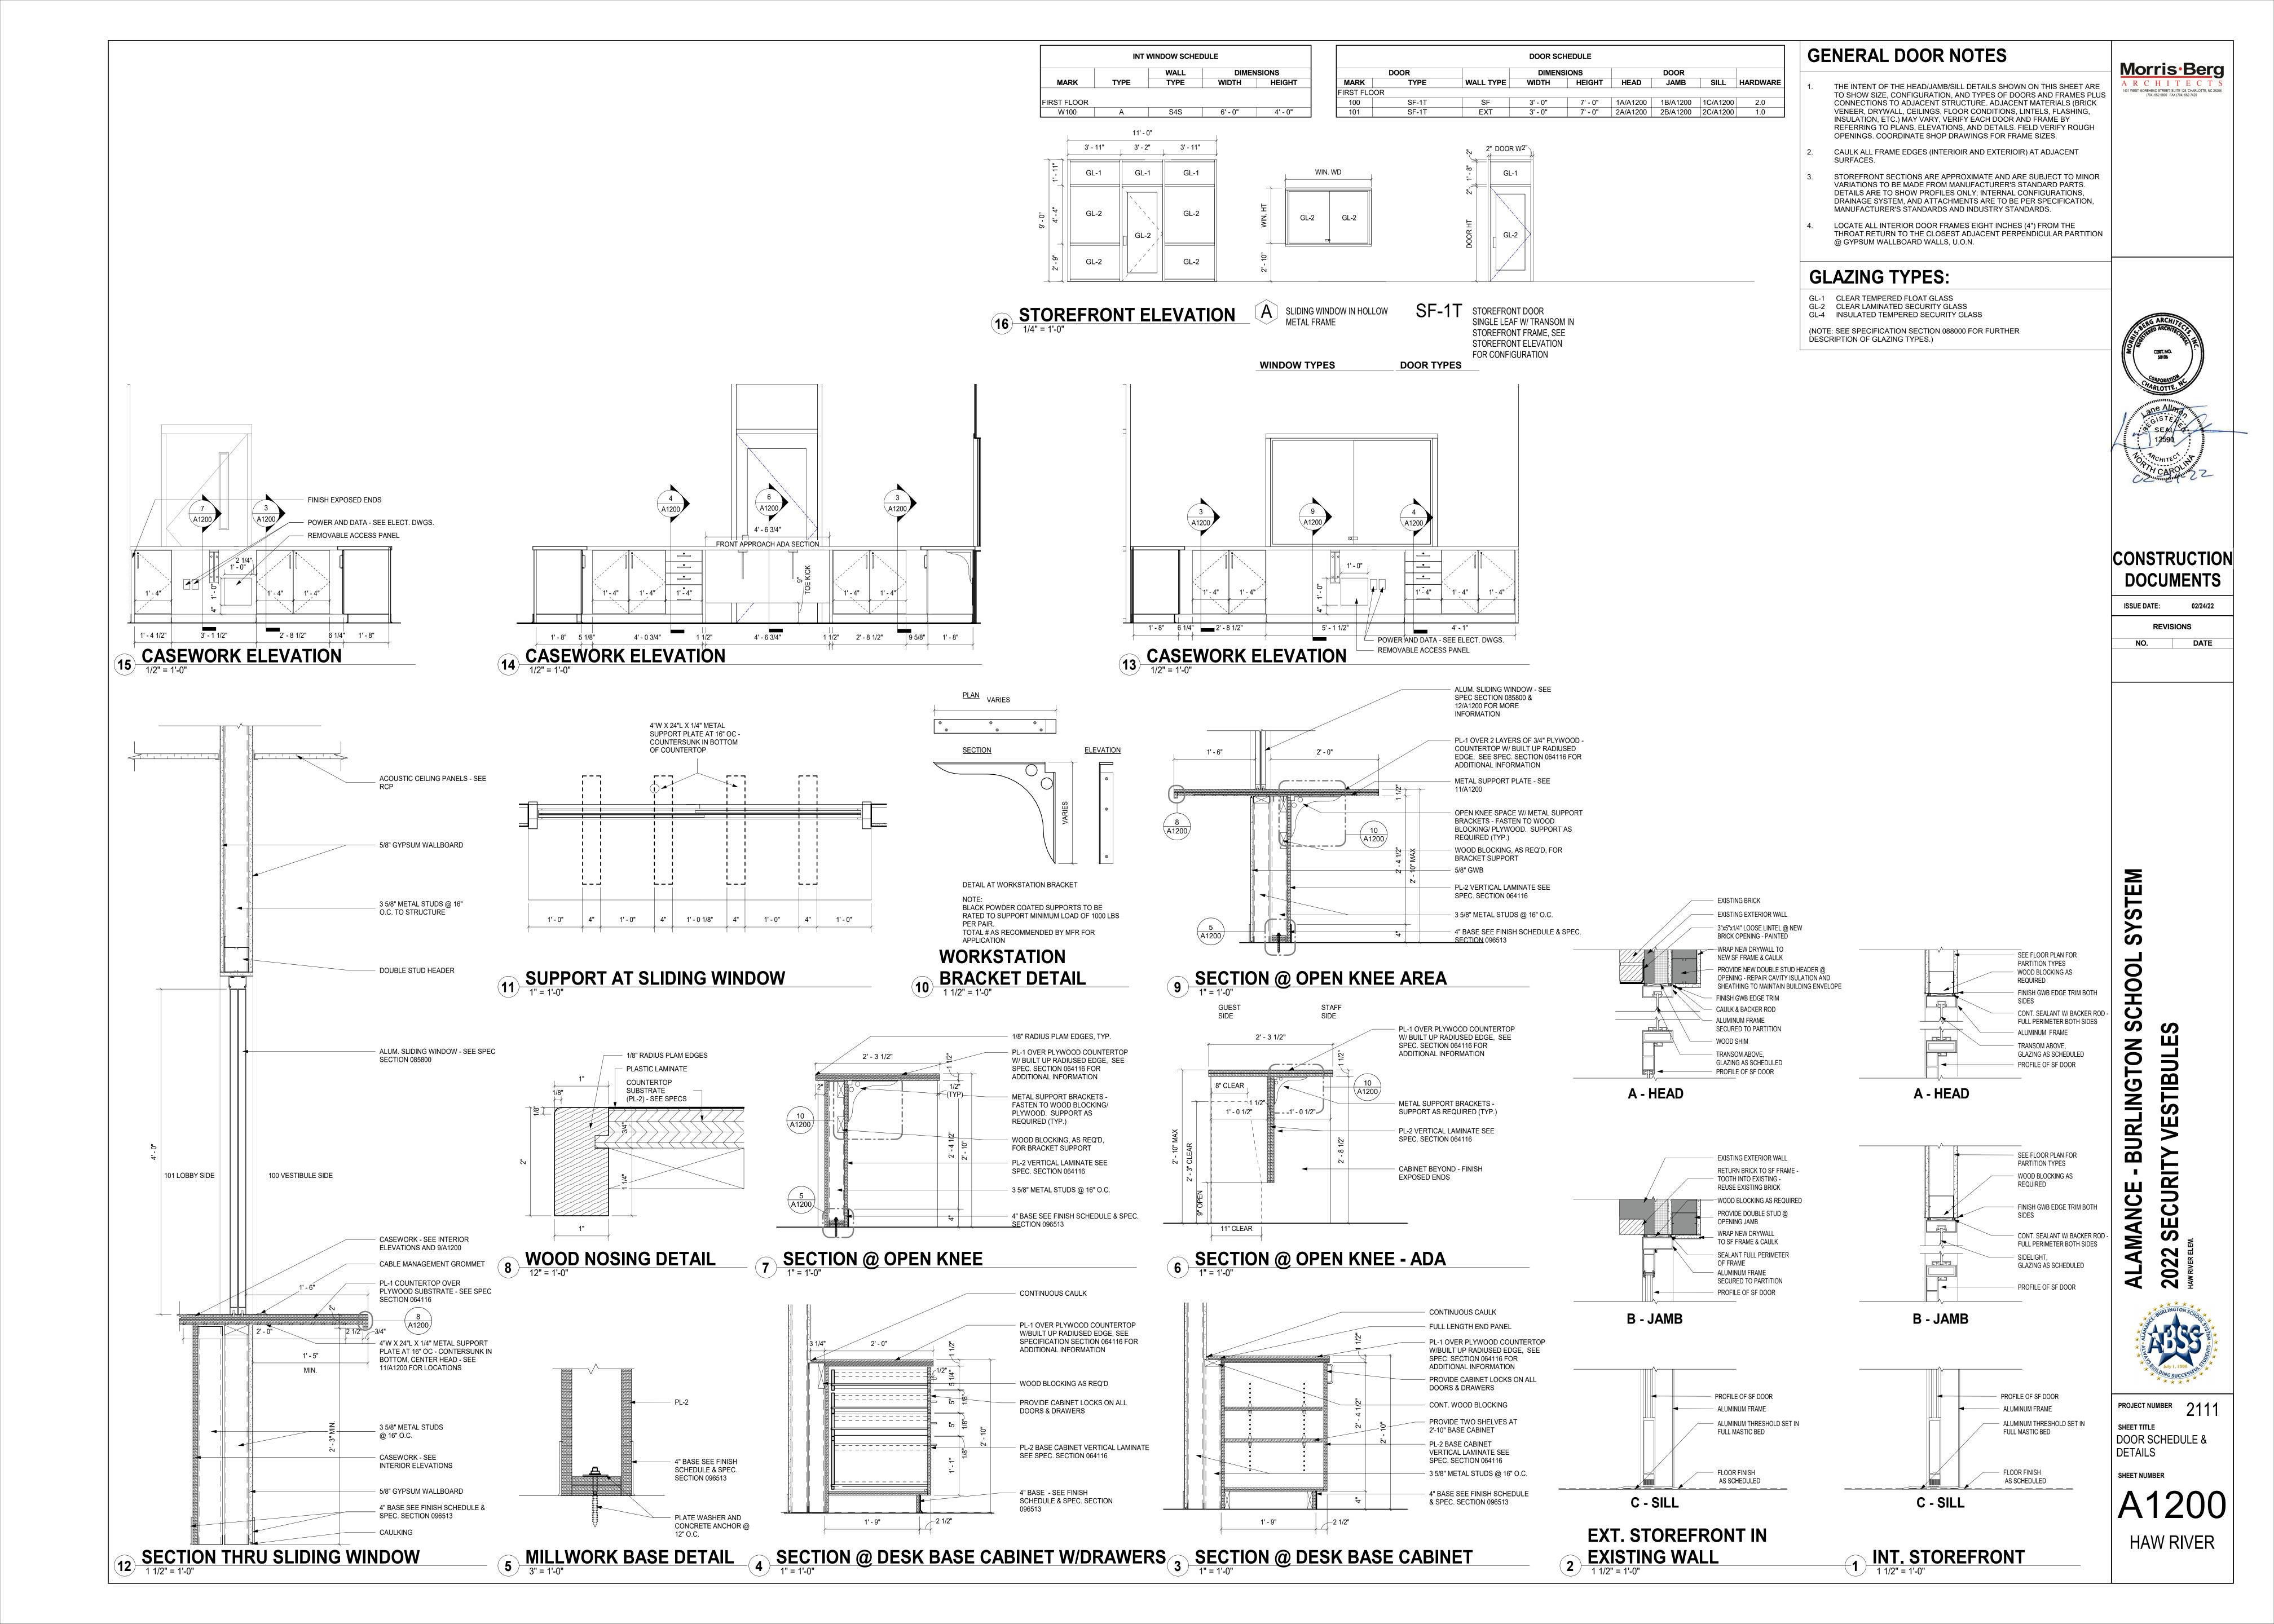

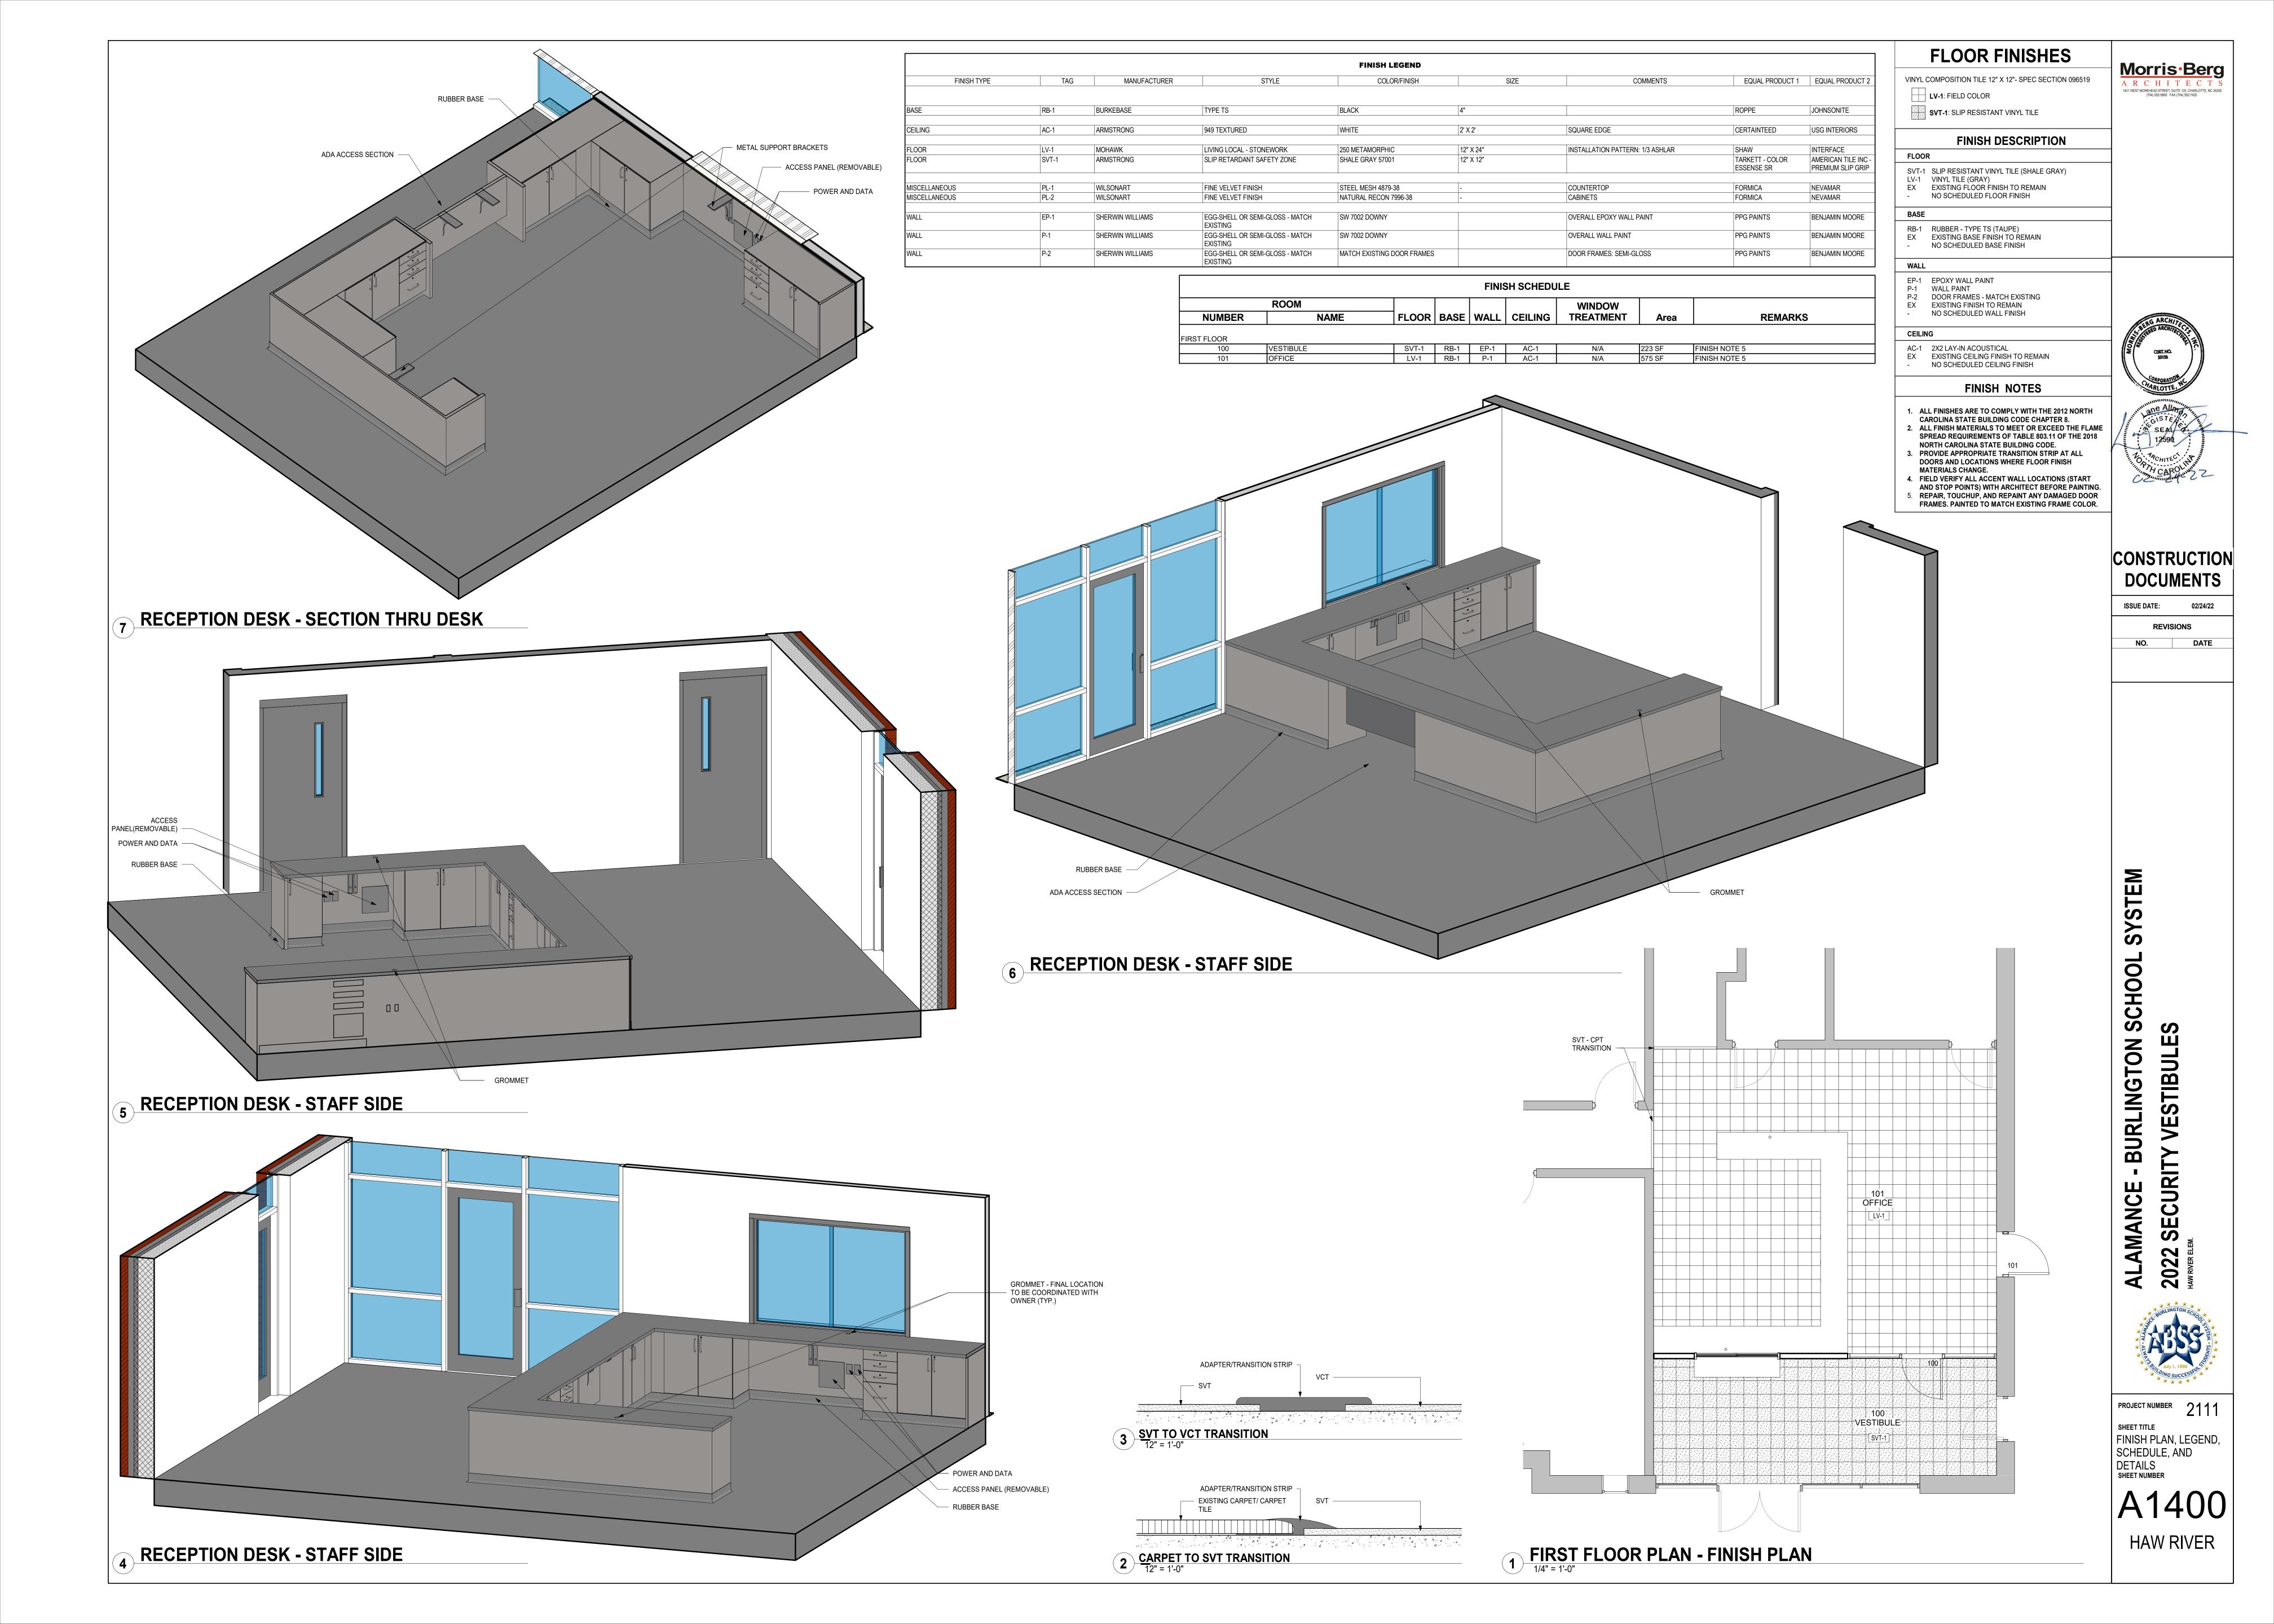


ENERGY REQUIREMENTS:	
MECHANICAL SYSTEMS, SERVICE SYSTEMS AND EQUIPMENT	
THERMAL ZONE	4A
EXTERIOR DESIGN CONDITIONS WINTER DRY BULB SUMMER DRY BULB	18 94
INTERIOR DESIGN CONDITIONS WINTER DRY BULB SUMMER DRY BULB RELATIVE HUMIDITY	72 75 30–60%
BUILDING HEATING LOAD	EXISTING
BUILDING COOLING LOAD	EXISTING
MECHANICAL SPACE CONDITIONING SYSTEM UNITARY DESCRIPTION OF UNIT HEATING EFFICIENCY COOLING EFFICIENCY HEAT OUTPUT OF UNIT COOLING OUTPUT OF UNIT BOILER	EXISTING EXISTING EXISTING EXISTING EXISTING
TOTAL BOILER OUTPUT CHILLIER TOTAL CHILLER OUTPUT	NA NA
LIST EQUIPMENT EFFICIENCIES	EXISTING
EQUIPMENT SCHEDULES WITH MOTORS (MECHANICAL SYSTEMS) MOTOR HORSEPOWER NUMBER OF PHASES MINIMUM EFFICIENCY MOTOR TYPE NUMBER OF POLES	EXISTING EXISTING EXISTING EXISTING EXISTING

MECHANICAL LEGEND									
K7 K7	EXISTING SUPPLY DIFFUSER TO REMAIN								
CFM	CUBIC FEET PER MINUTE								
AFF	ABOVE FINISHED FLOOR								
EER	ENERGY EFFICIENCY RATIO								
SP	STATIC PRESSURE								
(X)	EXISTING								

HVAC GENERAL NOTES

- 1. FURNISH ALL LABOR, MATERIAL AND EQUIPMENT REQUIRED FOR THE COMPLETE INSTALLATION AND OPERATION OF ALL SYSTEMS IN THIS SECTION OF WORK IN ACCORDANCE WITH RECOMMENDED PRACTICE AND ALL APPLICABLE CODES.
- 2. DO NOT SCALE DRAWINGS. SEE ARCHITECTURAL DRAWINGS & REFLECTED CEILING PLANS FOR EXACT LOCATION OF DOORS, WINDOWS, CEILING DIFFUSERS, ETC.
- 3. ALL MECHANICAL PERMITS AND INSPECTION FEES SHALL BE OBTAINED AND PAID FOR BY THE MECHANICAL CONTRACTOR.
- 4. MECHANICAL CONTRACTOR SHALL GUARANTEE ALL WORK AND MATERIALS FOR ONE YEAR, EFFECTIVE THE DAY THE PROJECT IS ACCEPTED BY THE OWNER. REFRIGERANT COMPRESSORS SHALL BE GUARANTEED FOR FIVE YEARS.
- 5. DRAWINGS ARE DIAGRAMMATIC AND MAY NOT SHOW ALL REQUIRED FITTINGS. CONTRACTOR IS RESPONSIBLE FOR COORDINATING THE TYPE, SIZE AND LOCATION OF ALL AIR DEVICES, DUCTWORK, PIPING AND EQUIPMENT WITH THE CEILING PLAN, LIGHTS, STRUCTURAL ELEMENTS AND OTHER TRADES. CONTRACTOR TO FURNISH AND INSTALL ALL BENDS, OFFSETS, ELBOWS, ETC. AS REQUIRED. VERIFY ALL CLEARANCES PRIOR TO FABRICATING DUCTWORK OR ORDERING EQUIPMENT.
- 6. CONTRACTOR IS RESPONSIBLE FOR PROVIDING MATERIALS AND INSTALLING THE WORK IN ACCORDANCE WITH ALL APPLICABLE LOCAL, STATE AND NATIONAL CODES.
- 7. DUCTWORK
- A. ALL DUCTWORK SHALL BE GALVANIZED SHEET METAL CONSTRUCTED IN ACCORDANCE WITH SMACNA STANDARDS WITH A MINIMUM PRESSURE CLASSIFICATION OF 2", SEAL CLASS C, WITH A MAXIMUM LEAKAGE RATE OF 5%.
- B. ALL SQUARE ELBOWS SHALL HAVE TURNING VANES. ALL RECTANGULAR ELBOWS SHALL BE LONG RADIUS UNLESS SPACE LIMITATIONS REQUIRE SQUARE ELBOWS.
- C. ALL DUCT DIMENSIONS SHOWN ARE INTERIOR CLEAR DIMENSIONS.
- D. PROVIDE A MANUAL BALANCING DAMPER AT ALL SUPPLY AND RETURN BRANCH TAKEOFFS.
- E. FLEXIBLE DUCT, IF SHOWN ON DRAWINGS, SHALL BE INSULATED ROUND DUCT WITH AN OUTER GLASS REINFORCED SILVER MYLAR JACKET ENCLOSING MIN. 1–1/2" THICK GLASS FIBER INSULATION AROUND A CONTINUOUS INNER LINER, AND SHALL CONFORM TO THE REQUIREMENTS OF U.L. 181 FOR CLASS 1 FLEXIBLE AIR DUCTS. MAXIMUM LENGTH OF FLEXIBLE DUCT SHALL BE 6 FEET. "R" VALUE TO MEET/EXCEED ENERGY CODE (R=5)
- F. ALL DUCT SYSTEMS ARE TO BE PER U.L. STANDARDS. DUCTS ARE TO BE INSTALLED WITH NO RESTRICTIONS AND AN ABSOLUTE MINIMUM AMOUNT OF AIR LEAKAGE.
- 8. ALL PIPING, DUCTS, VENTS, ETC., EXTENDING THROUGH WALLS & ROOF SHALL BE FLASHED & COUNTER-FLASHED IN A WATERPROOF MANNER.
- 9. ALL EQUIPMENT SHALL BE INSTALLED PER CODE & MANUFACTURER'S REQUIREMENTS FOR SERVICE AND ACCESS CLEARANCES.
- 10. ALL EQUIPMENT SHALL BE U.L LISTED.
- 11. LOCATE ALL THERMOSTATS AND SWITCHES 4'-0" ABOVE FINISHED FLOOR.
- 12. PRIOR TO BEGINNING ANY WORK. MECHANICAL CONTRACTOR IS RESPONSIBLE TO NOTIFY THE OWNER'S REPRESENTATIVE, ARCHITECT OR ENGINEER IF THE MECHANICAL DESIGN CONFLICTS WITH UNFORESEEN FIELD CONDITIONS.

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ALAMANCE - BURLINGTON SCHOOL SYSTEM 2022 SECURITY VESTIBULES

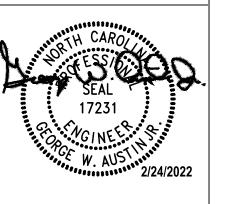


PROJECT NUMBER 2111

SHEET TITLE
MECHANICAL
PLANS, NOTES AND
SCHEDULES
SHEET NUMBER

M101 HAW RIVER



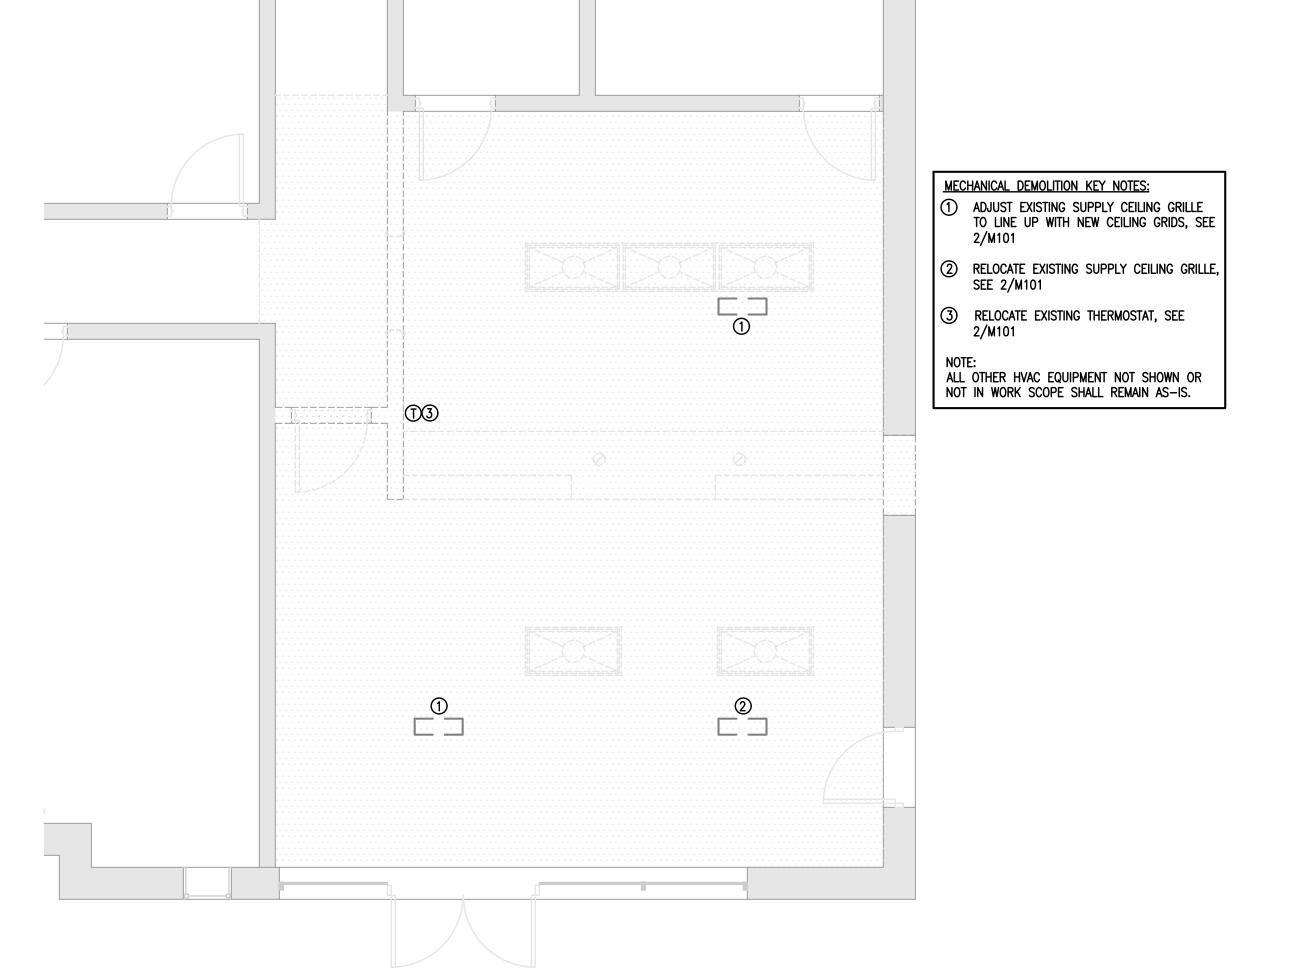

MECHANICAL DEMOLITION PLAN

SCALE: 1/4" = 1'-0"

SECTION 16010 ELECTRICAL SYSTEMS DESCRIPTIONS

A. PROJECT INCLUDES 1. ELECTRICAL SYSTEMS FOR THE FOLLOWING APPLICATIONS: REFER

OWNER-PROVIDED EQUIPMENT.

<u>AGENCY APPROVED BY THIS STATE</u>

- TO INDIVIDUAL SPECIFICATION SECTIONS FOLLOWING FOR DETAILED REQUIREMENTS. a. POWER AND DISTRIBUTION.
- b. LIGHTING, INCLUDING EXIT AND EMERGENCY LIGHTING. : FIRE ALARM AND LIFE SAFETY. d TELEPHONE e. POWER CONNECTIONS FOR HVAC, PLUMBING AND
- B. PRODUCTS 1. SYSTEMS, PRODUCTS, AND STANDARDS ARE LISTED IN INDIVIDUAL
- SPECIFICATION SECTIONS WHICH FOLLOW. 2. <u>ALL MATERIALS, DEVICES, APPLIANCES, AND EQUIPMENT SHALL BE</u> NEW AND LABEL LISTED BY AN APPROVED THIRD PARTY TESTING
- C. GENERAL PROJECT REQUIREMENTS 1. PROVIDE ALL WORK AND MATERIALS FOR THE INSTALLATION OF COMPLETE WRING SYSTEMS AS SPECIFIED HEREIN AND SHOWN ON THE DRAWINGS.
- 2. ALL ELECTRICAL PERMITS AND INSPECTION FEES SHALL BE OBTAINED AND PAID FOR BY THE ELECTRICAL CONTRACTOR.
- 3. ELECTRICAL CONTRACTOR SHALL GUARANTEE ALL WORK AND MATERIALS FOR ONE YEAR EFFECTIVE THE DAY THE PROJECT IS ACCEPTED BY THE OWNER.
- 4. ALL ELECTRICAL WORK SHALL BE IN ACCORDANCE WITH THE MOST RECENT ADOPTED VERSION OF THE N.F.P.A., NATIONAL ELECTRICAL CODE (N.E.C.), AND ALL APPLICABLE STATE AND LOCAL CODES.
- 5. ELECTRICAL CONTRACTOR SHALL PROVIDE ALL CUTTING AND PATCHING FOR INSTALLATION OF ELECTRICAL WORK AND REPAIR ANY DAMAGE DONE.
- 6. SHOP DRAWINGS AND CATALOG DATA SHALL BE SUBMITTED FOR ANY NEW LIGHTING FIXTURES, PANELBOARDS, DISCONNECT SWITCHES. STARTERS, WIRING DEVICES AND MISCELLANEOUS MATERIALS. SHOP DRAWNGS SHALL BE SUBMITTED AS SPECIFIED IN ARCHITECTURAL SPECIFICATIONS, OR AT A MINIMUM, PROVIDE AN ELECTRONIC "PDF" FILE OF ALL SUBMITTAL MATERIALS.
- 7. PROVIDE ENGRAVED PHENOLIC NAMEPLATES FOR ANY NEW PANELBOARDS, WIRING TROUGHS, MOTOR STARTERS AND DISCONNECT SWITCHES, LABELS SHALL BE WHITE LETTERS ON BLACK FIELD FOR "NORMAL" POWER SYSTEM AND WHITE LETTERS ON RED FIELD FOR "EMERGENCY" SYSTEM, NAMEPLATE SHALL INDICATE EQUIPMENT NAME, VOLTAGE AND CIRCUIT/FEEDER SERVING A. EQUIPMENT (WHERE APPLICABLE).
- 8. IT SHALL BE THE ELECTRICAL CONTRACTOR'S RESPONSIBILITY TO COORDINATE ANY ALTERATIONS TO THE POWER SERVICE WITH THE LOCAL POWER COMPANY PRIOR TO SUBMISSION OF BID. ANY ADDITIONAL COSTS REQUIRED BY THE POWER COMPANY SHALL BE THE RESPONSIBILITY OF THE ELECTRICAL CONTRACTOR AND SHALL BE INCLUDED IN THE BID.
- 9. ELECTRICAL CONTRACTOR SHALL TEST ALL WIRING FOR CONTINUITY AND GROUNDS PRIOR TO WIRING BEING ENERGIZED. FAULTY WIRING SHALL BE REPLACED.
- 10. ELECTRICAL CONTRACTOR SHALL CONNECT ALL HVAC, PLUMBING, AND OTHER CONTRACTOR OR OWNER FURNISHED EQUIPMEN REQUIRING ELECTRICAL CONNECTIONS (UNLESS OTHERWISE NOTED). CONTROL WRING FOR EQUIPMENT NOT PROVIDED BY THE ELECTRICAL CONTRACTOR, SHALL BE PROVIDED BY THE RESPECTIVE CONTRACTOR. COORDINATE WITH EQUIPMENT SHOP DRAWINGS AND FOUIPMENT CONTRACTOR FOR DISCONNECT SWITCH, CONDUIT, WIRING REQUIREMENTS, FUSE AND BREAKER SIZES, AND VOLTAGE REQUIREMENTS. ALL FINAL CONNECTIONS TO JUNCTION BOXES SHALL BE BY THE ELECTRICAL CONTRACTOR.
- 11. EACH BIDDER SHALL VISIT THE JOB SITE PRIOR TO BIDDING TO FAMILIARIZE HIMSELF/HERSELF WITH EXISTING CONDITIONS, FAILURE TO VISIT SITE SHALL NOT EXCUSE CONTRACTOR FROM PERFORMING REQUIRED WORK, NOR SHALL IT BE AN ACCEPTABLE REASON FOR REQUESTING ADDITIONS TO THE CONTRACT.
- 12. THE EXISTING PORTIONS OF THIS FACILITY WILL REMAIN IN OPERATION DURING THIS CONSTRUCTION. ELECTRICAL CONTRACTOR SHALL CAUSE AS LITTLE DISRUPTION AS POSSIBLE TO THE FUNCTIONING OF THE FACILITY IN ORDER TO MAINTAIN THE COMFORT AND SAFETY OF THE OCCUPANTS.
- 1.3 THIS PROJECT INVOLVES SOME WORK ON EXISTING FLECTRICAL FACILITIES. EXISTING FEEDER, BRANCH CIRCUITS, COMMUNICATIONS, RACEWAYS, ETC. WHICH ARE DISRUPTED BY THIS PROJECT SHALL BE RE-ROUTED AND/OR RE-FED FROM A NEW SOURCE AS REQUIRED TO MAINTAIN THEM IN FULL AND PERMANENT SERVICE.
- 14. THIS PROJECT INVOLVES SOME DEMOLITION WORK. THE ELECTRICAL CONTRACTOR SHALL BE RESPONSIBLE FOR PROPER REMOVAL OF WIRING, RACEWAY, FIXTURES, OUTLETS, ETC. AS NECESSARY TO ACCOMPLISH THE DEMOLITION WORK.
- BETWEEN BOXES INSTALLED IN OPPOSITE SIDES OF THE SAME FIRE-RATED WALL AS REQUIRED BY N.E.C. ART. 300.21 16. IF APPLICABLE, FIRE-STOPPING OF PENETRATIONS IN RATED WALLS

AND FLOORS SHALL BE ACCOMPLISHED IN ACCORDANCE WITH THE

15. IF APPLICABLE, PROVIDE MIN. 24" HORIZONTAL SEPARATION

- MOST RECENT, ADOPTED EDITION OF THE STATE BUILDING CODE USING APPROVED ASSEMBLIES SUCH AS THE FOLLOWING: CONDUIT PENETRATIONS OF 1, 2 OR 4 HOUR GYPBOARD WALLS -U.L. #W-L-1080.
- CONDUIT PENETRATIONS OF 1 OR 2 HOUR CONCRETE WALLS OR FLOORS, OR BLOCK WALLS - U.L. #C-AJ-1044. CONDUIT PENETRATIONS OF 4 HOUR CONCRETE WALLS OR FLOORS. OR BLOCK WALLS - U.L. #C-AJ-1044.
- 17. IF APPLICABLE, IN REQUIRED FIRE-RATED WALLS AND PARTITIONS, OPENINGS FOR INSTALLATION OF BOXES THAT ARE GREATER THAN 16 SOUARE INCHES SHALL BE PROTECTED AS REQUIRED BY A THIRD PARTY TESTING AGENCY APPROVED BY THIS STATE. COORDINATE CLOSELY WITH THE GENERAL CONTRACTOR TO INSURE THAT THE INTEGRITY OF THE RATING IS MAINTAINED
- 18. IT IS THE RESPONSIBILITY OF ALL CONTRACTORS AND TRADES TO COORDINATE THE INSTALLATION OF THEIR WORK WITH THE INSTALLATION OF WORK BY ALL OTHER CONTRACTORS AND TRADES. THE REQUIREMENTS OF THESE DRAWINGS, GENERAL REQUIREMENTS AND ALL ITEMS OF THE CONTRACT DOCUMENTS ARE EQUALLY BINDING ON ALL CONTRACTORS AND TRADES. EACH CONTRACTOR IS REQUIRED TO MAINTAIN FULL SETS OF THE CONTRACT DOCUMENTS FOR HIS EMPLOYEES' USE. ON THE PROJECT. TO ASSURE THAT ALL WORK IS PROPERLY COORDINATED AND INSTALLED WITH THE WORK OF OTHER CONTRACTORS AND TRADES.
- 19. WHENEVER THERE ARE DISCREPANCIES BETWEEN DRAWINGS, OR BETWEEN THE DRAWINGS AND SPECIFICATIONS, OR CONFLICTS WITHIN THE SPECIFICATIONS AND/OR DRAWINGS, AND SUCH DISCREPANCY IS NOT CALLED TO THE ENGINEER'S ATTENTION IN TIME TO PERMIT CLARIFICATION BY ADDENDUM, THE CONTRACTOR SHALL BASE HIS BID UPON PROVIDING THE BETTER QUALITY OR GREATER OF WORK OR MATERIAL CALLED FOR, SHALL SUBMIT A WRITTEN STATEMENT WITH HIS PROPOSAL NOTING SUCH DISCREPANCIES, AND SHALL SO FURNISH AND INSTALL SUCH BETTER QUALITY OR GREATER

QUANTITY UNLESS OTHERWISE ORDERED IN WRITING.

20. CONTRACTOR SHALL ASSUME FULL LIABILITY FOR ANY WORK, EQUIPMENT AND MATERIALS PURCHASED AND/OR INSTALLED THAT ARE IN DISCREPANCY, IF IT IS NOT FIRST BROUGHT TO THE ATTENTION OF THE ENGINEER, IN WRITING, FOR CLARIFICATION. IF NOT BROUGHT TO THE ENGINEER'S ATTENTION, CONTRACTOR SHALL PAY FOR ANY EQUIPMENT, MATERIALS AND WORK THAT MUST BE REPLACED

SECTION 16011 ELECTRICAL DEMOLITION

- THE EXTENT OF THE ELECTRICAL DEMOLITION WORK IS INDICATED ON THE ELECTRICAL AND ARCHITECTURAL DRAWINGS AND SPECIFIED
- WHILE DEMOLISHING THE EXISTING ELECTRICAL SYSTEMS, ALL NECESSARY MODIFICATIONS TO THE PORTIONS OF THE EXISTING SYSTEMS, WHICH ARE TO REMAIN, SHALL BE MADE SO THAT THE ENTIRE SYSTEM(S) CONTINUES TO FUNCTION AS INTENDED, EVEN AFTER DEMOLITION AND ASSOCIATED NEW CONSTRUCTION.
- ELECTRICAL DEMOLITION, RELOCATION OF EXISTING EQUIPMENT, AND ANY CUTTING AND PATCHING REQUIRED FOR THE INSTALLATION OF THIS NEW ELECTRICAL WORK IS THE RESPONSIBILITY OF THE ELECTRICAL CONTRACTOR.
- 4. THE ELECTRICAL CONTRACTOR SHALL FAMILIARIZE HIMSELF WITH THE EXISTING BUILDING AND WITH THE WORK OF ALL OTHER TRADES AND INCLUDE ALL WORK NECESSARY TO COMPLY WITH THE INTENT
- 5. IT SHALL BE UNDERSTOOD THAT FIELD CONDITIONS MAY BE ENCOUNTERED DURING THE EXECUTION OF THIS CONTRACT, WHICH WILL REQUIRE EXTENSION OR RELOCATION OF EXISTING SYSTEMS OR EQUIPMENT WHICH ARE NOT SPECIFICALLY SHOWN ON THE DRAWINGS, BUT WHICH ARE REQUIRED TO MEET THE STATED INTENT THAT THE BUILDING CONTINUES TO FUNCTION UNAFFECTED BY THE DEMOLITION AND ASSOCIATED NEW CONSTRUCTION. THIS CONTRACT SHALL INCLUDE SUCH WORK AS WOULD NORMALLY BE EXPECTED IN AN EXISTING BUILDING OF THIS AGE AND TYPE.
- 6. THE ELECTRICAL CONTRACTOR SHALL COORDINATE WITH THE GENERAL CONTRACTOR, REGARDING DEMOLITION OF THE EXISTING ELECTRICAL SYSTEMS, AS IS NECESSARY, SO THAT THE DEMOLITION OF THE GENERAL CONTRACTOR SHALL NOT DAMAGE THOSE PORTIONS OF THE ELECTRICAL SYSTEMS THAT ARE TO REMAIN IN SERVICE, ARE TO BE REUSED, OR ARE TO BECOME THE PROPERTY
- . ALL SALVAGEABLE MATERIALS RESULTING FROM DEMOLITION SHALL REMAIN THE PROPERTY OF THE OWNER. THE OWNER SHALL DETERMINE WHAT IS SALVAGEABLE. SALVAGEABLE ITEMS SHALL BE TURNED OVER TO THE OWNER. NON-SALVAGEABLE ITEMS SHALL BE PROPERLY DISPOSED OF BY THE ELECTRICAL CONTRACTOR.
- 8. EQUIPMENT OR MATERIALS WHICH ARE TO BE REUSED OR TURNED OVER TO THE OWNER SHALL BE CAREFULLY REMOVED AND STORED IN A CLEAN, DRY AREA. SHOULD THE CONTRACTOR ENCOUNTER SUCH EQUIPMENT WHICH IS NOT IN SATISFACTORY CONDITION FOR
- NOTIFY THE ARCHITECT/ENGINEER IMMEDIATELY. 9. ELECTRICAL CONTRACTOR SHALL DISCONNECT ELECTRICAL SERVICES TO ALL EQUIPMENT REQUIRING REMOVAL, AND SHALL DISCONNECT

(EXISTING)

AUTO-

DIALER

(EXISTING)

TO UL APPROVED

OFFSITE MONITORING

SERVICE OR CENTRAL

EX. 120V CCT. ⁻

REUSE AND NOT IN WORKING ORDER, THE CONTRACTOR SHALL

ELECTRICAL SPECIFICATIONS

- AND REMOVE ALL RECEPTACLES AND TELEPHONE OUTLETS FROM PARTITIONS TO BE DEMOLISHED. CONDUIT SHALL BE REMOVED BACK TO THE POINT WHERE IT WILL BE CONCEALED AT THE COMPLETION OF THIS CONTRACT. WIRE AND CABLE SHALL BE REMOVED BACK TO THE FIRST OUTLET BOX, PANELBOARD, CABINET OR TERMINATION POINT WHICH IS TO REMAIN.
- 10. WHERE NEW WALL OR FLOOR FINISHES CONFLICT WITH EXISTING ELECTRICAL WORK THAT IS TO REMAIN. RELOCATE THE ELECTRICAL WORK INVOLVED OR PROVIDE BOX EXTENSIONS OR SIMILAR DEVICES AND REINSTALL ON THE NEW FINISH.
- 11. REMOVE ANY ABANDONED CONDUITS, WIRING AND BOXES ENCOUNTERED WITHIN THE PROJECT EXTENTS.

RACEWAYS AND BOXES

- A. PROJECT INCLUDES 1. ELECTRICAL CONDUIT, TUBING, SURFACE RACEWAYS, BOXES, AND
- WRING METHODS: a. CONCEALED OR EXPOSED INDOOR WIRING: ZINC-COATED ELECTRICAL METALLIC TUBING FOR SIZES 1/2" THROUGH 4" INTERMEDIATE STEEL CONDUIT FOR SIZES LARGER THAN 4".
- c. CONCEALED OUTDOOR WIRING: INTERMEDIATE STEEL CONDUIT OR SCHEDULE 80 OR 40 PVC.
- CONNECTION TO EQUIPMENT: FLEXIBLE METAL CONDUIT,
- 2. FITTINGS FOR ELECTRICAL METALLIC TUBING SHALL BE HEXAGONAL GALVANIZED STEEL, GLAND TYPE, COMPRESSION OR SET-SCREW TYPE AND THREADLESS.
- RACEWAY ACCESSORY MATERIALS: a. CONDUIT BODIES: SHALL COMPLY WITH N.E.C. REQUIREMENTS. b. SURFACE RACEWAYS, METALLIC: GALVANIZED STEEL, WITH SNAP-ON COVERS AND IVORY ENAMEL FINISH. SURFACE RACEWAY MAY ONLY BE USED WITH PRIOR, WRITTEN APPROVAL FROM OWNER, ARCHITECT AND ENGINEER. c. ALL EMPTY CONDUITS SHALL BE PROVIDED WITH PULL WIRES AND NYLON BUSHINGS AT BOTH ENDS.
- a. CABINET BOXES: CODE GAUGE GALVANIZED SHEET METAL, NEMA 1 -INDOORS, NEMA 3R -OUTDOORS OR IN DAMP b. PULL AND JUNCTION BOXES: CODE GAUGE GALVANIZED SHEET
- LOCATIONS c. METAL OUTLET, DEVICE AND SMALL WIRING BOXES: SHALL
- PROPERLY SUPPORT ALL CONDUITS WITH STRAPS AND CLAMPS PER THE MOST RECENT, ADOPTED EDITIONS OF THE N.E.C. AND STATE BUILDING CODE. RUN ALL CONDUITS PARALLEL OR PERPENDICULAR TO BUILDING WALLS/SURFACES.
- 2. MINIMUM CONDUIT SIZE ABOVE SLAB/GRADE SHALL BE 1/2". MINIMUM CONDUIT SIZE IN OR BELOW FLOOR SLAB SHALL BE 3/4".
- 3. RACEWAY PENETRATIONS THROUGH FLOOR SLABS AND FIRE-RATED WALLS SHALL BE FILLED WITH IMPERVIOUS, NON-SHRINK GROUT SUFFICIENTLY TIGHT TO PREVENT THE TRANSFER OF SMOKE, FIRE, WATER, AND DUST.
- JOINTS MADE WATER-TIGHT BY USING A POLYTETRA-FLUOROETHYLENE TAPE. ALL METALLIC UNDERGROUND CONDUITS SHALL BE THOROUGHLY COATED WITH TWO COATS OF ASPHALTUM OR BITUMASTIC. APPROVED SEALS SHALL BE PROVIDED IN HAZARDOUS LOCATIONS AS REQUIRED BY THE N.E.C.
- 5. PROVIDE PULLWIRE IN ALL EMPTY CONDUITS.

- A. PROJECT INCLUDES 1. WIRES, CABLES, AND CONNECTORS FOR POWER, LIGHTING, SIGNAL, CONTROL AND RELATED SYSTEMS RATED 600 VOLTS AND LESS.
 - c. INSULATION: THHN/THWN. d. JACKETS: FACTORY-APPLIED NYLON OR PVC, COLOR CODED: "BLACK/RED/BLUE/WHITE" FOR "A", "B" AND "C" PHASES, NEUTRAL, RESPECTIVELY FOR 120/208-VOLT SYSTEM. "BROWN/ORANGE/YELLOW/LIGHT GRAY" FOR "A", "B" AND "C" PHASES, NEUTRAL, RESPECTIVELY FOR 277/480-VOLT SYSTEM. e. BRANCH CIRCUIT CONDUCTORS: SHALL NOT BE SMALLER THAN #12 AWG. CONTROL WIRING MAY BE #14 AWG.

┌───────────────┞├──**┼┼┞┼──∫** E.O.L.

CONNECT NEW DEVICES TO -

THE SAME AREA.

EXISTING ALARM AND SIGNAL

CIRCUITS ALREADY SERVING

ROOF/PENTHOUSE

FIRST FLOOR

- f. NEUTRAL CONDUCTORS: #10 AWG MINIMUM FOR ALL MULTIWIRE BRANCH CIRCUITS. a. "MC" TYPE CABLE WITH INTEGRAL, GREEN, INSULATED GROUND CONDUCTOR, MAY ONLY BE UTILIZED WHERE CONCEALED TO SERVE BRANCH CIRCUITS SIZED #8 AWG OR SMALLER NOT BE
- h. WIRING TO LIGHTING FIXTURES SHALL BE AS REQUIRED BY U.L.
- a. PORTABLE CORD FOR FLEXIBLE PENDANT LEADS TO OUTLETS AND EQUIPMENT: UL TYPE S.
- b. CONTROL/SIGNAL TRANSMISSION MEDIA: TWISTED PAIR TYPE. 3. CONNECTORS: UL LISTED SOLDERLESS METAL CONNECTORS WITH APPROPRIATE TEMPERATURE RATINGS.

a. RECEPTACLES: 15-AMP DUPLEX (HUBBELL #5252, OR

c. ISOLATED GROUND RECEPTACLES: LISTED AND LABELED.

APPROVED EQUIVALENT), 20-AMP DUPLEX (HUBBELL #5362, OR

b. GROUND-FAULT INTERRUPTER (GFI) RECEPTACLES: FEED-THRU

TYPE GROUND-FAULT CIRCUIT INTERRUPTER WITH INTEGRAL

DUPLEX RECEPTACLES. (HUBBELL #GF-5362, OR APPROVED

EQUIPMENT GROUNDING CONTACTS INTEGRAL TO RECEPTACLE

d. PLUGS AND PLUG CONNECTOR: AS SPECIFIED ON DRAWINGS.

e. SNAP SWITCHES: SINGLE-POLE, 20 AMPERE (HUBBELL #1221,

WALL PLATES: SINGLE AND COMBINATION TYPES, NYLON

MATCH EXISTING BUILDING STANDARD, UNLESS OTHERWISE

q. COLOR OF ALL DEVICES AND COVERPLATES TO BE WHITE

1. DUPLEX RECEPTACLES ON DEDICATED CIRCUIT SHALL BE 20-AMP.

2. DEVICE/OUTLET BOXES SHALL NOT BE MOUNTED BACK-TO-BACK IN

TAMPER RESISTANT TYPE, UNLESS PERMITTED OTHERWISE BY NEC

4. WEATHERPROOF COVERS SHALL PROTECT THE OUTLET WHILE IN USE,

METALLIC WITH OUTLET MOUNTED IN HORIZONTAL ORIENTATION.

5. PROVIDE ALL OUTLETS (INCLUDING TELEPHONE) WITH APPROPRIATE

1. ELECTRICAL SERVICE AND DISTRIBUTION INCLUDING GROUNDING.

a. GROUNDING EQUIPMENT: COPPER CONDUCTORS, N.E.C.

APPROVED CONNECTORS.

PANELBOARDS: ARE EXISTING.

OUTDOORS AND WET AREAS.

CUTI FR-HAMMFR.

CUTLER-HAMMER

OVERCURRENT PROTECTIVE DEVICES:

4. DISCONNECT SWITCHES:

a. HFAVY—DUTY TYPF

CIRCUIT BREAKERS AND DEVICES.

PANELBOARDS, OVERCURRENT PROTECTIVE DEVICES, DISCONNECT

b. GROUNDING ELECTRODES: COPPER-CLAD STEEL GROUND RODS.

c. GROUNDING SYSTEM: SHALL COMPLY WITH N.E.C. ARTICLE 250.

PANELBOARD TYPE: LIGHTING AND APPLIANCE BRANCH

e. ACCEPTABLE MANUFACTURERS: SQUARE D, SIEMENS, G.E. OR

b. NEMA 1 ENCLOSURE - INDOORS, NEMA 3R ENCLOSURE

FUSED OR NON-FUSED AS INDICATED ON DRAWINGS.

U.L. LISTED AS PART OF THE DISCONNECT.

a. OVERCURRENT PROTECTIVE DEVICES: INTEGRAL TO

d. FUSED SWITCHES SHALL HAVE REJECTION-TYPE FUSE CLIPS.

e. ALL DISCONNECTS SHALL BE HEAVY-DUTY RATED. AND SHALL

BEING OPENED, WITHOUT DEFEATING THE INTERLOCK. THE

f. ACCEPTABLE MANUFACTURERS: SQUARE D, SIEMENS, G.E. OR

HAVE A MECHANICAL INTERLOCK TO PREVENT THE DOOR FROM

MECHANICAL INTERLOCK SHALL ALSO PREVENT ACTIVATING THE

SWITCH WHEN THE DOOR IS OPEN. THE MECHANICAL INTERLOCK

SHALL BE DE-FEATABLE BY A SPECIAL TOOL, AND SHALL BE

CIRCUIT PANELBOARDS, BOLT ON CIRCUIT BREAKERS. d. SERIES RATING IS NOT ALLOWED FOR ALL NEW PANELBOARDS,

EQUIVALENT TO LEVITON #M5999. COVERS SHALL BE EXTRA DEEP,

3. ALL 125V AND 250V NON-LOCKED TYPE RECEPTACLES SHALL BE

OTHER DUPLEX RECEPTACLES MAY BE 15-AMP.

MATCHING EXISTING BUILDING STANDARD, UNLESS OTHERWISE

OR APPROVED EQUIVALENT), THREE-WAY, 20 AMPERE

(HUBBELL #1223, OR APPROVED EQUIVALENT).

1. WIRING DEVICES AND COMPONENTS:

EQUIVALENT)

CONSTRUCTION

NOTED ON DRAWINGS.

NOTED ON DRAWINGS.

APPROVED EQUIVALENT).

WRING DEVICES

C. EXECUTION

COVERPLATES.

SERVICE AND DISTRIBUTION

GROUNDING

PANELBOARDS:

B. PRODUCTS

- CABINETS FOR ELECTRICAL POWER AND SIGNAL DISTRIBUTION. A. PROJECT INCLUDES
 - 1. WRING DEVICES FOR ELECTRICAL SERVICE. B. PRODUCTS
- b. EXPOSED OUTDOOR WIRING: RIGID OR INTERMEDIATE STEEL
- d. UNDERGROUND WIRING, SINGLE RUN: SCHEDULE 80 OR 40
- e. UNDERGROUND WIRING, GROUPED: SCHEDULE 80 OR 40 PVC. LIQUIDTIGHT AT EXTERIOR OR IN DAMP LOCATIONS.

- 4. BOXES AND FITTINGS:
 - METAL, NEMA 1 -INDOORS, NEMA 3R -OUTDOORS OR IN DAMP
- COMPLY WITH UL 514A. d. CONDUIT RUN THROUGH BUILDING EXPANSION JOINTS SHALL HAVE APPROPRIATE CONDUIT EXPANSION FITTINGS.
- C. EXECUTION
- 4. CONDUITS INSTALLED UNDERGROUND OR IN CONCRETE SHALL HAVE

1. WRE COMPONENTS: a. CONDUCTORS FOR POWER AND LIGHTING CIRCUITS: SOLID CONDUCTORS FOR SIZES #14 AWG THROUGH #8 AWG, STRANDED CONDUCTORS FOR #6 AWG AND LARGER. b. CONDUCTOR MATERIAL: COPPER.

- PANEL BOARDS b. FUSIBLE SWITCHES: RATING AS INDICATED ON DRAWNGS AND
- SUITABLE FOR USE. c. MOLDED CASE CIRCUIT BREAKERS: BOLT-ON TYPE, AUTOMATIC THERMAL MAGNETIC TYPE CALIBRATED FOR 40-DEGREES C, OR AMBIENT COMPENSATION. d. ACCEPTABLE MANUFACTURERS: SQUARE D, SIEMENS, G.E. OR CUTLER-HAMMER.
- a. SIZES INDICATED ON DRAWINGS. b. CLASS R-5, TIME DELAY, UNLESS OTHERWISE NOTED. c. A SET OF 3 SPARE FUSES OF EACH SIZE AND TYPE SHALL BE
- FURNISHED TO THE OWNER. d. ACCEPTABLE MANUFACTURERS: BUSSMAN, GOULD SHAWMUT OR LITTLE FUSE.
- EXECUTION 1. ALL NEW MULTI-CIRCUIT HOMERUNS SHALL BE PROTECTED WITH A MULTI-POLE, SIMULTANEOUS-TRIP CIRCUIT BREAKER PER N.E.C. 210-4B.
- 2. ALL TERMINATION'S ON NEW ELECTRICAL GEAR/EQUIPMENT (i.e. PANELBOARDS, DISCONNECT SWITCHES, etc.) SHALL HAVE DUAL RATED 60-DEGREE / 75-DEGREE LUGS/TERMINALS.
- 3. PROVIDE A COMPLETE PANEL DIRECTORY FOR EACH PANEL. DIRECTORY SHALL BE TYPE WRITTEN FOR ALL CIRCUITS.
- 4. ALL SPARE BREAKER HANDLES SHALL BE IN THE OFF POSITION.

INTERIOR AND EXTERIOR LIGHTING

CONSTRUCTION.

- PROJECT INCLUDES 1. INTERIOR AND EXTERIOR LIGHTING FIXTURES, LAMPS, BALLASTS, EMERGENCY LIGHTING UNITS, EXIT SIGNS AND ACCESSORIES.
- PRODUCTS 1. INTERIOR AND EXTERIOR LIGHTING COMPONENTS (SEE "LIGHT
- FIXTURE SCHEDULE"): a. EXIT SIGNS: L.E.D., SELF-POWERED NI-CAD BATTERY TYPE, MIN 90 MINUTE CAPACITY.
- b. EMERGENCY LIGHTING UNITS: L.E.D. LAMPS, INTEGRAL, NI-CAD BATTERY, MIN. 90 MINUTE CAPACITY.
- c. ACRYLIC LENS: A-12, .125" MINIMUM. d. L.E.D. LAMPS SHALL BE MINIMUM OF 85 CRI, 3500 KELVIN IN INTERIOR LIGHT FIXTURES AND 5000 KELVIN IN EXTERIOR LIGHT FIXTURES, UNLESS NOTED OTHERWISE ON LIGHT FIXTURE
- LAY-IN FIXTURES SHALL BE SUSPENDED FROM BUILDING STRUCTURE WITH MINIMUM OF FOUR WIRES ONE AT EACH CORNER, FIXTURES SHALL ALSO BE ATTACHED TO GRID SYSTEM WITH EARTHQUAKE CLIPS. DO NOT SUPPORT FIXTURES FROM CEILING GRID.
- 2. SEE ARCHITECTURAL "REFLECTED CEILING PLANS" OR ELECTRICAL LIGHTING PLANS FOR EXACT LOCATIONS OF ALL LIGHT FIXTURES.
- COORDINATE LIGHT FIXTURE MOUNTING METHODS WITH ARCHITECTURAL FINISHES PRIOR TO ORDERING MATERIAL. COORDINATE FIXTURE TYPE AND TRIM WITH CEILING
- 4. DOWNLIGHTS INSTALLED AT INACCESSIBLE CEILINGS SHALL
- HAVE BOTTOM ACCESS LISTING. 5. COORDINATE LIGHT FIXTURE VOLTAGE WITH VOLTAGE OF LIGHTING CIRCUIT SERVING LIGHT FIXTURE.
- 6. ANY FIXTURES INDICATED ON THE PLANS TO BE CONTROLLED WITH A DIMMER SHALL BE PROVIDED WITH DIMMING BALLAST/DRIVER COMPATIBLE WITH THE LIGHTING CONTROLS. PROVIDE ALL ACCESSORIES AND/OR WIRING TO MAKE COMPLETE.
- 7. CONNECT ALL BATTERY UNITS IN EXIT AND EMERGENCY EGRESS LIGHT FIXTURES TO LOCAL LIGHTING CIRCUIT AHEAD OF ALL SWITCHING UNLESS NOTED OTHERWISE.
- 8. LIGHTING FIXTURES INDICATED TO BE INSTALLED IN WET OR DAMP LOCATIONS SHALL BE UL LISTED AND LABELED "WET" OR "DAMP" ACCORDINGLY.
- 9. IN COMPLIANCE WITH THE ENERGY CONSERVATION CODE, ALL RECESSED LIGHT FIXTURES INSTALLED IN THE BUILDING THERMAL ENVELOPE SHALL BE IC-RATED AND LABELED FOR MEETING ASTM E 283. THESE FIXTURES SHALL BE SEALED WITH A GASKET OR CAULK BETWEEN THE HOUSING AND THE INTERIOR WALL OR CEILING
- 10. CATALOG NUMBERS GIVEN ON PLANS OR IN SPECIFICATIONS DENOTE MINIMUM QUALITY AND PERFORMANCE REQUIRED. APPROVED EQUIVALENT EQUIPMENT BY OTHER MANUFACTURERS IS ACCEPTABLE.

END OF SPECIFICATIONS

APPENDIX B BUILDING CODE SUMMARY FOR ALL COMMERCIAL PROJECTS (ELECTRICAL DESIGN) ELECTRICAL SYSTEM AND EQUIPMENT METHOD OF COMPLIANCE

PERFORMANCE

☐ PRESCRIPTIVE PERFORMANCE ASHRAE 90.1: LIGHTING SHEDULE LAMP TYPE REQUIRED IN FIXTURE SEE LIGHT FIXTURE SCHEDULE NUMBER OF LAMPS IN FIXTURE BALLAST TYPE USED IN FIXTURE

NUMBER OF BALLASTS IN FIXTURE TOTAL WATTAGE PER FIXTURE TOTAL INTERIOR WATTAGE SPECIFIED VS. ALLOWED 0.288 KW vs. 0.957 KW TOTAL EXTERIOR WATTAGE SPECIFIED VS. ALLOWED N/A TOTAL EXTERIOR WATTAGE SPECIFIED VS. ALLOWED

EXISTING EXTERIOR LIGHTING TO REMAIN.

ADDITIONAL EFFICIENCY PACKAGE OPTIONS

- ☐ C406.2 MORE EFFICIENT HVAC EQUIPMENT PERFORMANCE ■ C406.3 REDUCED LIGHTING POWER DENSITY
- C406.4 ENHANCED DIGITAL LIGHTING CONTROLS

ENERGY CODE: PRESCRIPTIVE

(NON-TRADABLE)

C406.5 ON-SITE RENEWABLE ENERGY C406.6 DEDICATED OUTDOOR AIR SYSTEM C406.7 REDUCED ENERGY USE IN SERVICE WATER HEATING

CONSTRUCTION **DOCUMENTS**

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ARCHITECT

ISSUE DATE: 02/24/22 **REVISIONS**

NO. DATE

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ELECTRICAL SHEET INDEX

E001 ELECTRICAL SYMBOLS, NOTES AND SPECIFICATIONS E101 ELECTRICAL FLOOR PLANS AND SCHEDULES

FIRE ALARM SEQUENCE OF OPERATION

UPON CHANGE IN STATUS OF ANY DEVICE ON THE SYSTEM, THE FIRE ALARM CONTROL PANEL SHALL ACTIVATE AUDIBLE AND VISIBLE CHANGE INDICATORS AND DISPLAY THE SYSTEM POINT NUMBER, POINT DESCRIPTION AND MESSAGE ASSOCIATED WITH THE POINT. ACTIVATION OF ANY MANUAL STATION, KITCHEN HOOD EXTINGUISHING SYSTEM, WATERFLOW DEVICE, SMOKE DETECTOR, HEAT DETECTOR, SUPERVISORY DEVICE OR OTHER INITIATING

* TRANSMIT AN ALARM SIGNAL TO A UL LISTED CENTRAL STATION. * ACTIVATE THE AUDIBLE AND VISUAL NOTIFICATION APPLIANCES ON THE FLOOR.

* RELEASE THE DOOR LOCKING SYSTEM.

MANUAL STATION OPERATION SHALL

RISE OR LARGE ASSEMBLY.

DEVICE WILL CAUSE THE FOLLOWING FUNCTIONS TO OCCUR:

* TRANSMIT AN ALARM SIGNAL TO A UL LISTED CENTRAL STATION.

SHALL BE DISTINCTLY DIFFERENT THAN A TROUBLE SIGNAL.

SMOKE DETECTOR OR HEAT DETECTOR OPERATION SHALL: + ACTIVATE AUDIBLE AND VISIBLE STATUS CHANGE INDICATORS AND DISPLAY THE SYSTEM POINT NUMBER, POINT DESCRIPTION, AND MESSAGE ASSOCIATED WITH THE POINT ON THE

+ ACTIVATE AUDIBLE AND VISUAL STATUS CHANGE INDICATORS AND DISPLAY POINT

NUMBER, POINT DESCRIPTION, AND MESSAGE ASSOCIATED WITH THE POINT ON THE

* ACTIVATE THE AUDIBLE AND VISUAL NOTIFICATION APPLIANCES ON THE FLOOR. * SHUT DOWN AHU"S. SUPERVISORY DEVICE ACTIVATION, INCLUDING VALVE SUPERVISORY DEVICES SHALL + ACTIVATE AUDIBLE AND VISIBLE STATUS CHANGE INDICATORS AND DISPLAY THE SYSTEM POINT NUMBER, POINT DESCRIPTION, AND MESSAGE ASSOCIATED WITH THE POINT ON THE

* TRANSMIT A SUPERVISORY SIGNAL TO A UL LISTED CENTRAL STATION. THIS SIGNAL

THE POINT AND TRANSMIT A TROUBLE SIGNAL TO A UL LISTED CENTRAL STATION.

REMOVAL OF ANY DEVICE, WIRING DISARRANGEMENT, OR SYSTEM COMPONENT FAILURE SHALL DISPLAY ON THE OPERATOR TERMINAL THE CHANGE OF STATUS. TIME. DATE POINT DESCRIPTION ON A POINT BY POINT BASIS, AND THE MESSAGE ASSOCIATED WITH

INDICATION EVACUATION TONE SHALL BE THREE BEAT TEMPORAL PATTERN, UNLESS HIGH

PARTIAL FIRE ALARM SYSTEM RISER DIAGRAM

FIRE ALARM SYSTEM RISER NOTES

EXISTING

W/ BATTERY

BACKUP

ALL DEVICE QUANTITIES SHALL BE TAKEN OFF OF THE

FLOOR PLANS. THE RISER DIAGRAM IS DIAGRAMMATIC

- ALL FIRE ALARM INITIATING DEVICES SHALL MATCH EXISTING FIRE ALARM SYSTEM EQUIPMENT...
- ALL FIRE ALARM WIRING SHALL BE PER MANUFACTURER'S
- RECOMMENDATIONS AND N.E.C. REQUIREMENTS. CONFIRM NUMBER AND LOCATIONS OF ALL TAMPER AND FLOW SWITCHES WITH SPRINKLER CONTRACTOR AND CIVIL

ENGINEER PRIOR TO ROUGH-IN.

- INSTALLATION OF ALL WIRING AND DEVICES SHALL BE IN ACCORDANCE WITH ALL APPLICABLE CITY CODES AND NFPA
- 7. UPON FIRE ALARM SYSTEM GOING INTO ALARM, ALL DOOR SECURITY MAG-LOCKS AND ALL DOOR HOLD-OPENS SHALL BE RELEASED, ALLOWING SECUIRTY DOORS TO

OPEN AND FIRE DOORS TO CLOSE.

PROJECT/OWNER.

- 8. PROVIDE ADDITIONAL CONTROL CARDS, POWER SUPPLIES, EXTENDER CABINET(S), etc. AS NEEDED TO ACCOMMODATE DEVICES SHOWN ON PLANS. ANY ADDITIONAL CABINETS REQUIRED SHALL BE LOCATED AS DIRECTED BY OWNER.
- 10. ALL ITEMS SHOWN DASHED ARE EXISTING TO REMAIN. 11. BUILDING FIRE ALARM SYSTEM SHALL COMPLY WITH NFPA

72-2013 AND N.C. FIRE CODE 907.2.12.2.

9. PROVIDE ADDITIONAL FIRE ALARM DEVICES AS DIRECTED BY

THE FIRE MARSHAL AT NO ADDITIONAL COST TO THE

OF CIRCUITS.

- <u>GENERAL</u>
- CONDUIT RUN CONCEALED IN FLOOR OR BELOW SLAB/GRADE.
- CONDUIT RUN EXPOSED ON SURFACE. CIRCUIT HOME RUN. NUMBER OF ARROWS INDICATES NUMBER
- 120/208 VOLT DISTRIBUITION OR BRANCH CIRCUIT PANELBOARD FLUSH OR SURFACE-MOUNTED JUNCTION BOX.
- DUPLEX, GROUNDING TYPE, 120 VOLT, 20 AMP, RECEPTACLE WITH COVERPLATE. PROVIDE #12 GREEN GROUND JUMPER. MOUNT 18" A.F.F. TO CENTER UNLESS OTHERWISE SHOWN. SAME AS DUPLEX RECEPTACLE ABOVE EXCEPT MOUNTED

FLUSH MOUNTED DATA OUTLET, 18" A.F.F. TO CENTER, UNLESS OTHERWISE NOTED. RUN ONE 3/4" EMPTY CONDUIT TO 12" ABOVE ACCESSIBLE CEILING. LEAVE PULL WIRE IN CONDUIT. PROVIDE BLANK COVER.

ABOVE COUNTERTOP BACKSPLASH, OR AT 46" A.F.F. TO

CENTER WHERE THERE IS NO ASSOCIATED CASEWORK.

FLUSH MOUNTED COMBINATION TELE./DATA OUTLET, 18" A.F.F. TO CENTER, UNLESS OTHERWISE NOTED. RUN ONE 3/4" EMPTY CONDUIT TO 12" ABOVE ACCESSIBLE CEILING. LEAVE PULL WIRE IN CONDUIT. PROVIDE BLANK COVER.

WALL/COLUMN, OR AT HEIGHT INDICATED.

SAME AS FLUSH TELE./DATA OUTLET ABOVE EXCEPT MOUNTED

6" ABOVE COUNTER BACKSPLASH, 46" A.F.F. TO CENTER ON

<u>DESCRIPTION</u>

- FLUSH MOUNTED COMBINATION TELE./DATA OUTLET, 18" A.F.F. TO CENTER, UNLESS OTHERWISE NOTED. RUN ONE 3/4" EMPTY CONDUIT TO 12" ABOVE ACCESSIBLE CEILING. LEAVE
- SAME AS FLUSH TELE./DATA OUTLET ABOVE EXCEPT MOUNTED 6" ABOVE COUNTER BACKSPLASH, 46" A.F.F. TO CENTER ON WALL/COLUMN, OR AT HEIGHT INDICATED.

<u>FIRE ALARM SYSTEM</u>

- FACP FIRE ALARM SYSTEM CONTROL PANEL WITH BATTERY BACK-UP.
- MOUNT 46" A.F.F. TO CENTER. FIRE ALARM SYSTEM COMBINATION HORN/STROBE INDICATING
- RATING OF STROBE. ALL STROBES SHALL BE 110 CANDELA UNLESS OTHERWISE NOTED.

SWITCH WITH PLATE. MOUNT 46" A.F.F. TO CENTER.

APPROVED EQUIVALENT BY LEVITON OR WATT-STOPPER.

SK SAME AS SINGLE-POLE SWITCH ABOVE EXCEPT WITH KEYED

- **CONTROLS** SINGLE POLE, 120/277 VOLT, 20 AMP, RECESSED WALL
- OCCUPANCY SENSOR WALL SWITCH, 120/277-VOLT, 1000W. RECESSED WALL-MOUNTED SENSOR WITH COVERPLATE. DUAL Soc Technology passive infrared/ultrasonic technology. AUTOMATIC ON, 30-SEC TO 30-MIN TIME DELAY ADJUSTMENT TO TURN LIGHTS OFF. HUBBELL LIGHTHAWK SERIES, OR

<u>LIGHTING</u>

EXIT SIGN WITH BATTERY. NUMBER OF FACES AND ARROWS AS INDICATED ON DRAWINGS. LETTERS INDICATE TYPE. SEE LIGHT FIXTURE SCHEDULE.



PROJECT NUMBER 211 SHEET TITLE ELECTRICAL SYMBOLS, NOTES

SHEET NUMBER

AND SPECIFICATIONS

HAW RIVER

ELECTRICAL SYMBOL SCHEDULE

- <u>DESCRIPTION</u> **COMMUNICATIONS** CONDUIT RUN CONCEALED IN CEILING OR IN WALL.
 - PULL WIRE IN CONDUIT. PROVIDE BLANK COVER.

- FIRE ALARM SYSTEM MANUAL PULL STATION. ADA COMPLIANT.
- DEVICE. ADA COMPLIANT. MOUNT 80" A.F.F. TO BOTTOM OF STROBE OR 6" BELOW FINISHED CEILING TO TOP OF STROBE. WHICHEVER IS LOWER. SUBSCRIPT INDICATES CANDELA
- FIRE ALARM SYSTEM PHOTOELECTRIC TYPE AUTOMATIC SMOKE DETECTOR.
- SWITCH


<u>SYMBOL</u>

<u>DESCRIPTION</u>

• LED LIGHTING FIXTURE. LETTER INDICATES TYPE. SEE LIGHT FIXTURE SCHEDULE. CEILING OR WALL MOUNTED EMERGENCY BATTERY PACK. SEE

LIGHT FIXTURE SCHEDULE.



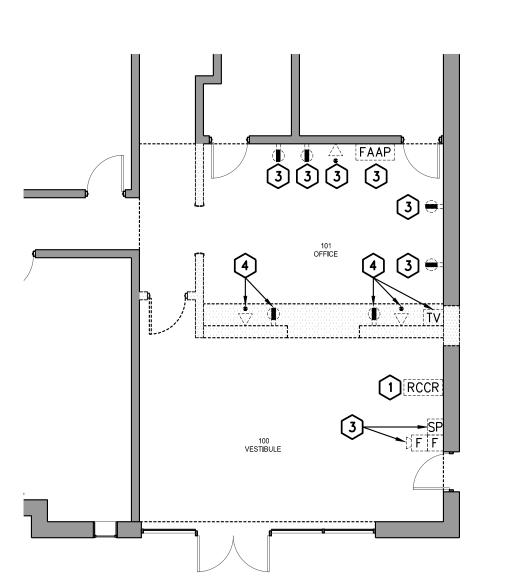


SCALE: 1/8"=1'-0"


2 ELECTRICAL REFLECTED CEILINGFLOOR PLAN - DEMOLITION SCALE: 1/8"=1'-0"

	LIGHT FIXTURE SCHEDULE												
A	DESCRIPTION:	2'x 4' RECESSED LED TROFFER WITH A-12.125 ACRYLIC PRISMATIC LENS, STEEL HOUSING WITH WHITE ENAMEL FINISH			LAMP INFO:	NO. LED		TYPE LUM/35K	BALLAST TYPE:	ELECTRONIC	NOTE(S):		
	MANUFACTURER:	LITHONIA	CATALOG SERIES:	2BLT4 40L ADP EZ1 LP840 FA0	EQUIVA	ENT MAN	NUFACT:	APF	APPROVED EQUIVALENT			. WATTAGE:	32
XA	DESCRIPTION:	L.E.D. EXIT SIGN WITH WE WITH ARROWS AND NO. C		HOUSING AND RED LETTERS. ON PLANS	LAMP INFO:	NO.		IYPE .E.D.	BALLAST TYPE:	NA	NOTE(S):		
	MANUFACTURER:	SURE-LITES	CATALOG SERIES:	LPX	EQUIVA	ENT MAN	NUFACT:	APF	APPROVED EQUIVALENT		TOTAL FIXT	. WATTAGE:	2.5
XC	DESCRIPTION:		BATTERY PACK LIGHT FIXTURE, POLYCARBONATE HOUSING INISH, (2)—LED LIGHT HEADS.		LAMP INFO:	NO.		TYPE LED	BALLAST TYPE:	NA	NOTE(S):		
	MANUFACTURER:	SURE-LITES	CATALOG SERIES:	SEL50	EQUIVALENT MANUFACT:		APPROVED EQUIVALENT			TOTAL FIXT	. WATTAGE:	1.0	
	LIGHT FIXTURE SCHEDULE NOTES												


- 1. VOLTAGES OF LIGHT FIXTURES SHALL BE COORDINATED WITH LIGHTING CIRCUIT TO WHICH FIXTURE IS CONNECTED.
- 2. ALL EXIT SIGNS AND EMERGENCY LIGHTS SHALL BE CONNECTED TO EXISTING EMERGENCY GENERATOR CIRCUIT AHEAD OF LIGHTING CONTROLS.
- 3. COORDINATE MOUNTING REQUIREMENTS OF ALL FIXTURES WITH ARCHITECTURAL PLANS AND FINISH SCHEDULES.
- 4. FLANGES AND TRIMS SHALL MATCH CEILING TYPES.

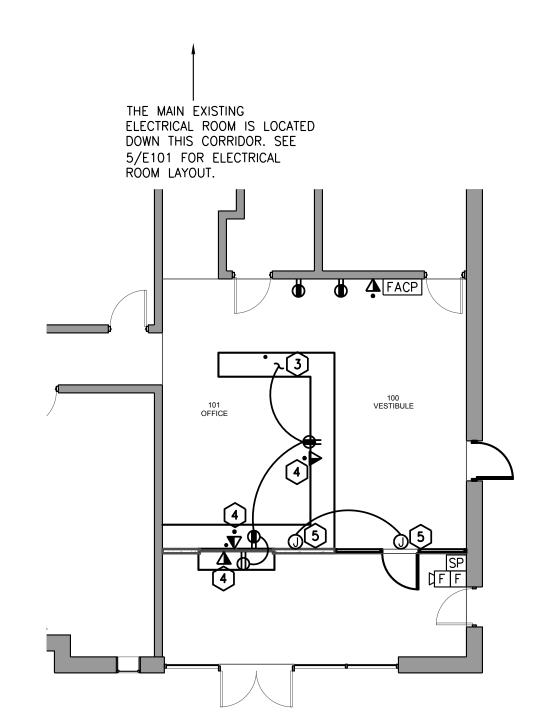

3 ELECTRICAL FLOOR PLAN - NEW WORK
SCALE: 1/8"=1'-0"

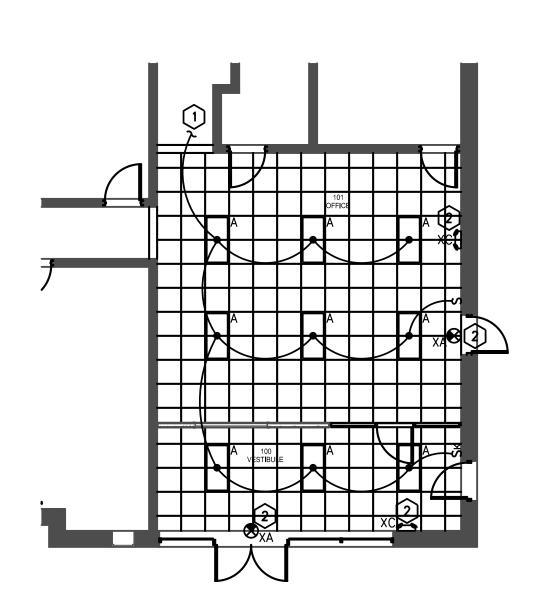


ELECTRICAL REFLECTED CEILINGFLOOR PLAN - NEW WORK
SCALE: 1/8"=1'-0"

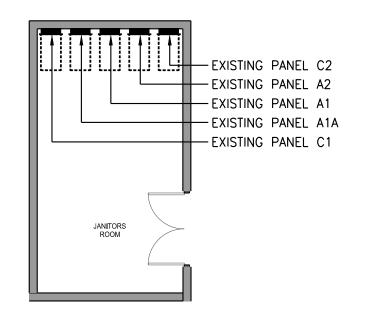

5 ELECTRICAL ROOM FLOOR PLAN - EXISTING
SCALE: 1/8"=1'-0"

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CONSTRUCTION **DOCUMENTS**

ISSUE DATE: 02/24/22 **REVISIONS** NO. DATE

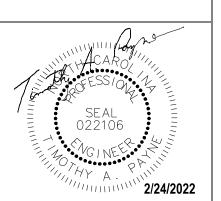BURLINGTON SCHOOL

ALAMANCE 202



PROJECT NUMBER 2111

SHEET TITLE ELECTRICAL FLOOR PLANS AND SCHEDULES SHEET NUMBER

HAW RIVER



DEMOLITION PLAN NOTES

EXISTING CARD READER TO BE RELOCATED.

2 EXISTING LIGHT FIXTURE TO BE REMOVED.

3 EXISTING TO REMAIN.

4 EXISTING TO BE REMOVED.

- EXTEND EXISTING CONDUIT AND CONDUCTORS AS REQUIRED FOR CONNECTION OF NEW LAY-IN LIGHT FIXTURES.
- 2 CONNECT TO NEW LOCAL BRANCH CIRCUIT CONDUCTORS UN-SWITCHED.
- 3 CONNECT TO EXISTING RECEPTACLE BRANCH CIRCUIT CONDUCTORS.
- install 3/4" empty conduit to above accessible ceiling for connection to existing data/telephone system.
- JUNCTION BOX FOR CONNECTION TO REMOTE DOOR CONTROL EQUIPMENT.